

 Kenton C. Wara, Surve

 Phone (317) 776-8495

 Fax
 (317) 776-9628

Sutte 188 One Hamilton County Square Noblesville, Indiana 46060-2230

January 11, 2006

TO: Hamilton County Drainage Board

RE: Village of West Clay, Section 6001 and 6002 Arm.

Attached is a petition filed by Brenwick Development along with a non-enforcement requests, plans, calculations, quantity summary and assessment roll for the Section 6001 and 6002 Arm, Village of West Clay Drain to be located in Clay Township. The plans for Village of West Clay Section 6001 include all storm sewers for the drainage system for Section 6002 of the Village of West Clay. I have reviewed the submittals and petition and have found each to be in proper form.

Due to design changes made after the plans had been approved, Sheets 101 to 105, 601, 603, 605, and 607 to 612 were replaced in the plans. These revised sheets were submitted to the Surveyor's Office on October 31, 2005.

I have made a personal inspection of the land described in the petition. Upon doing so, I believe that the drain is practicable, will improve the public health, benefit a public highway, and be of public utility and that the costs, damages and expenses of the proposed drain will probably be less than the benefits accruing to the owners of land likely to be benefited. The drain will consist of the following:

12" RCP	1,970 ft.	21" RCP	692 ft.	30" RCP	236 ft.
15" RCP	1,768 ft.	24" RCP	1,202 ft.	36" RCP	475 ft.
18" RCP	1,449 ft.	27" RCP	73 ft.	42" RCP	266 ft.

The total length of the drain will be 8,131 feet.

The retention ponds (Schricker Pond, Taggert Pond and Beveridge Pond) which are located in Goldwater Park, Block S of Section 6002, and Block V of Section 6002 respectively, are not to be considered part of the regulated drain for maintenance purposes. Only the inlets and outlets will be maintained as part of the regulated drain. The maintenance of the ponds shall be the responsibility of the Homeowners Association as per the subdivision covenants on pages 11 and 12, sections 4 and 5, and recorded in the Office of the Hamilton County Recorder as instrument number 199909946964. The Board will however, retain jurisdiction for ensuring the storage volume for which the ponds were designed will be retained, thereby, allowing no fill or easement encroachments.

The subsurface drains (SSD) under curbs are not to be part of the regulated drain. This is per the agreement between Brenwick Development and the Hamilton County Commissioners on April 26, 1999. (See Commissioner's Minute Book 93, Pages 565-566).

I have reviewed the plans and believe the drain will benefit each lot equally. Therefore, I recommend each lot be assessed equally. I also believe that no damages will result to landowners by the construction of this drain. I recommend a maintenance assessment of \$5.00 per acre, \$5.00 per acre for roadways, with a \$120.00 minimum. With this assessment the total annual assessment for this drain/this section will be \$11,873.10.

The petitioner has submitted surety for the proposed drain at this time. The sureties which are in the form of a Performance Bond are as follows:

Agent: Bond Safeguard Insurance Company Date: July 8, 2005 Number: 5016989 For: Storm Sewers Amount: \$494,825.00 Agent: Bond Safeguard Insurance Company Date; July 8, 2005 Number: 5016990 For: Erosion Control Amount: \$67,200.00

Agent: Bond Safeguard Insurance Company Date: September 14, 2005 Number: 5018858 For: Erosion Control for Section 6002 Amount: \$34,800.00

Parcels assessed for this drain may be assessed for the Long Branch Drain at sometime in the future. Parcels assessed for this drain will also be assessed for the J. W. Brendel Drain.

I believe this proposed drain meets the requirements for Urban Drain Classification as set out in IC 36-9-27-67 to 69. Therefore, this drain shall be designated as an Urban Drain.

I recommend that upon approval of the above proposed drain that the Board also approve the attached non-enforcement requests. The requests are for the reduction of the regulated drain easement to those easement widths as shown on the secondary plats for Village of West Clay Section 6001 and Village of West Clay Section 6002 as recorded in the office of the Hamilton County Recorder.

Is for this proposed drain for March 27, 2006.

Kenton C. Ward Hamilton County Surveyor

KCW/pll

(Revised 06/08/04)

STATE OF INDIANA

COUNTY OF HAMILTON)

TO: HAMILTON COUNTY DRAINAGE BOARD

)

% Hamilton County Surveyor One Hamilton County Square, Suite 188 Noblesville, IN. 46060-2230

In the matter of	Village of WestClay	Subdivision, Section
6001	Drain Petition.	

Petitioner is the owner of all lots in the land affected by the proposed new regulated drain. The drainage will affect various lots in <u>Village of WestClay</u>, a subdivision in Hamilton County, Indiana. The general route of such drainage shall be in existing easements and along public roads as shown in the plans on file in the Surveyor's Office.

Petitioner believes that the cost, damages and expenses of the proposed improvement will be less than the benefits which will result to the owners of the land likely to be benefited thereby. Petitioner believes the proposed improvements will:

- (a) improve public health
- (b) benefit a public street
- (c) be of public utility

Petitioner agrees to pay the cost of construction of the drainage system and requests periodic maintenance assessments by the Board thereafter.

The Petitioner also agrees to the following:

- 1. To provide the Drainage Board a Performance Bond or Non-Revocable Letter of Credit for the portion of the drainage system which will be made a regulated drain. The bond will be in the amount of 120% of the Engineer's estimate. The bond will be in effect until construction of 100% of the system is completed and so certified by the Engineer.
- 2. The Petitioner shall retain an Engineer throughout the construction phase. At completion of the project the Petitioner's Engineer shall certify that the drainage system which is to be maintained as a regulated drain has been constructed as per construction plans.
- 3. The Petitioner agrees to request in writing to the County Surveyor any changes from the approved plan and must receive written authorization from the County Surveyor prior to implementation of the change. All changes shall be documented and given to the Surveyor to be placed in the Drain file.
- 4. The Petitioner shall instruct his Engineer to provide a reproducible print on a 24" x 36" Mylar of the final design of the Drainage System. This shall be submitted to the County Surveyor prior to the release of the Performance Bond.
- 5. The Petitioner shall comply with the Erosion Control Plan as specified on the construction plans. Failure to comply with the Erosion Control Plan shall be determined by the Board as being an obstruction to the drainage system. The County Surveyor shall immediately install or repair the needed measures at Petitioners cost as per IC 36-9-27-46.

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The Petitioner further requests that the Drain be classified as an Urban Drain as per IC 36-9-27-69(d).

RECORDED OWNER(S) OF LAND INVOLVED

Signed

Printed Name

Printed Name Communities, LLC BRENNECK

7/7/05 Date

Date

Signed

Signed

Printed Name

Printed Name

Date

Date

Adobe PDF Fillable Form

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FINDINGS AND ORDER

CONCERNING THE MAINTENANCE OF THE

Village of West Clay Drain, Sections 6001 and 6002

On this 27th day of March 2006, the Hamilton County Drainage Board has held a hearing on the Maintenance Report and Schedule of Assessments of the Village of West Clay Drain, Sections 6001 and 6002.

Evidence has been heard. Objections were presented and considered. The Board then adopted the original/amended Schedule of Assessments. The Board now finds that the annual maintenance assessment will be less than the benefits to the landowners and issues this order declaring that this Maintenance Fund be established.

HAMILTON COUNTY DRAINAGE BOARD

Member

Member

Attest. Seprette Masking

Villages of West Clay Section 6001 & 6002 GASB 34 Calculation

Villages of West Clay Drain: Section 6001 & 6002: 8131ft JW Brendle Drain-Village of West Clay Sec. 6001 Relocation: 1432 ft

Total Footage = 9563 **Bond Amount** = \$468,354

Villages of West Clay Drain: Section 6001 & 6002: .85(\$468,354) = \$398,100.90 **JW Brendle Drain-Village of West Clay Sec. 6001 Relocation:** .15(\$468,354) = \$70,253.10

Note: Bonds were posted at 120% of the engineers estimate. This dollar amount is based upon the engineer's estimate.

BEFORE THE HAMILTON COUNTY DRAINAGE BOARD IN THE MATTER OF

Village of West Clay Drain, Sections 6001 and 6002

NOTICE

To Whom It May Concern and:_____

Notice is hereby given of the hearing of the Hamilton County Drainage Board on the Village of West Clay Drain, Sections 6001 and 6002 on March 27, 2006 at 9:25 A.M. in Commissioners Court, Hamilton County Judicial Center, One Hamilton County Square, Noblesville, Indiana, and which construction and maintenance reports of the Surveyor and the Schedule of Assessments made by the Drainage Board have been filed and are available for public inspection in the office of the Hamilton County Surveyor.

Hamilton County Drainage Board

Attest: Lynette Mosbaugh

ONE TIME ONLY

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BEFORE THE HAMILTON COUNTY DRAINAGE BOARD IN THE MATTER OF THE

Village of West Clay Drain, Sections 6001 and 6002

NOTICE

Notice is hereby given pursuant to Section 405 of the 1965 Indiana Drainage Code that this Board, prior to final adjournment on March 27, 2006 has issued an order adopting the Schedule of Assessments, filed the same and made public announcement thereof at the hearing and ordered publication. If judicial review of the findings and order of the Board is not requested pursuant to Article Eight of this code within twenty (20) days from the date of this publication, the order shall be conclusive.

Hamilton County Drainage Board

Attest: Lynette Mosbaugh

ONE TIME ONLY

CERTIFICATE OF COMPLETION AND COMPLIANCE

TO: HAMILTON COUNTY SURVEYOR

RE: Village of West Clay Section 6002

I hereby certify that:

- 1. I am a Register Engineer in the State of Indiana
- 2. I am familiar with the plans and specifications for the above referenced subdivision.
- 3. I have personally observed and supervised the completion of the Drainage Facilities for the above referenced subdivision, and
- 4. The drainage facilities within the above referenced subdivision to the best of my knowledge, information, and belief have been installed and completed in conformity with all plans and specifications.
- 5. The drainage facilities within the above referenced subdivision to the best of my knowledge, information and belief have been correctly represented on the Record Drawings, Digital Record Drawings and the Structure Data Spreadsheet.

Signature:	-73-1	Date:	4-7-06
Type or print name:	Brandon T Burke, P.E.		
Business /Address:	The Schneider Corporation		
-	12821 E. New Market Street, Suite 301	, Carmel,	IN 46032

Telephone: (317) 826-6401

INDIANA REGISTRATION NUMBER

PE 10000075

SEAL





Kenton C. Ward, CFM Surveyor of Hamilton County Phone (317) 776-8495 Fax (317) 776-9628

Suite 188 One Hamilton County Square Noblesville, Indiana 46060-2230

To: Hamilton County Drainage Board

March 4, 2008

Re: Village of West Clay: Section 6001 & 6002

Attached are as-builts, certificate of completion & compliance, and other information for Village of West Clay Section 6001 & 6002. An inspection of the drainage facilities for this section has been made and the facilities were found to be complete and acceptable.

During construction, changes were made to the drain, which will alter the plans submitted with my report for this drain-dated January 11, 2006. The report was approved by the Board at the hearing held March 27, 2006 (See Drainage Board Minutes Book 9, Pages 139-141). The changes are as follows:

				Up			
Structure:	Length:	Size	Material:	Invert:	Dn_Invert	Grade:	Changes(ft):
652-650	22	12	RCP	902.6	902.48	0.54	
664-663	29	12	RCP	902.77	902.59	0.62	
663-649	87	12	RCP	902.6	901.98	0.71	
669-648A	67	12	RCP	901.81	901.47	0.51	
623-622	120	15	RCP	895.11	894.79	0.27	-11
622-621	259	21	RCP	894.71	894.05	0.25	5
621-Ex	66	21	RCP	894.03	893.62	0.62	-5
636-635	47	12	RCP	898.16	898.07	0.3	-2
635-634	77	12	RCP	898.07	897.84	0.3	2
634-633	118	15	RCP	897.84	897.52	0.27	
633-632	29	15	RCP	897.52	897.43	0.31	
632-631	172	15	<u>RC</u> P	897.43	896.92	0.3	
631-630	176	18	RCP	896.92	896.39	0.3	
630-629	29	21	RCP	896.04	895.99	0.17	-1
629-628	178	24	RCP	895.99	895.7	0.16	
628-627	122	24	RCP	895.7	895.48	0.18	1
627-626	29	24	RCP	895.48	895.33	0.52	-3
626-625	73	27	RCP	895.33	895.13	0.27	
651-650	29	15	RCP	906.84	901.64	0.48	
650-649	42	15	RCP	901.5	901.34	0.38	2
649-648B	55	15	RCP	901.34	901.09	0.91	-1

648B-648A	110	15	RCP	901.09	900.09	0.91	2
648A-648	28	18	RCP	900.09	899.55	0.19	-1
648-647	57	18	RCP	899.55	899.2	0.61	2
647-646	109	18	RCP	899.2	898.45	0.68	
646-645	157	21	RCP	898.45	897.41	0.66	
645-644	155	24	RCP	897.41	896.86	0.35	1
644-643	103	24	RCP	896.86	896.17	0.67	
643-642	102	24	RCP	896.17	895.53	0.63	
642-641	50	24	RCP	895.53	895.12	0.82	7
661-660	29	12	RCP	900.16	899.51	2.24	· · · ·
660-646	230	15	RCP	899.51	898.45	0.46	1
701-697	53	15	RCP	901.44	901.24	0.38	· · · · · · · · · · · · · · · · · · ·
699-698	57	12	RCP	902.37	902.16	0.37	
698-697	22	12	RCP	902.16	901.91	1.14	
697-696	156	15	RCP	901.24	900.02	0.78	-1
696-695	239	18	RCP	900.02	898.15	0.78	-3
757-753	25	12	RCP	902.21	901.92	0.24	
753-752	29	12	RCP	901.92	901.85	0.24	·····
752-751	172	12	RCP	901.85	900.9	0.24	
751-750	81	12	RCP	900.9	900.32	0.72	1
750-726A	103	24	RCP	900.32	900	0.72	-1
712-711	55	12	RCP	903.45	903.06	0.71	1
711-710	146	12	RCP	903.06	902.02	0.71	
710-709	38	18	RCP	902.02	902.02	0.47	
709-708	230	18	RCP	901.84	901.84	0.47	
708-707	145	18	RCP	900.78	899.2	1.09	<u>-1</u> -1
707-706	29	18	RCP	899.2	898.84	1.09	
706-705	104	18	RCP	898.84	897.44	1.35	
716-710	29	12	RCP	902.21	902.02		1
715-709	51	12	RCP	902.08	902.02	0.66 0.47	
714-713	29	12	RCP	903.56	901.84		
713-708	62	12	RCP	903.2	903.2	1.24	
726-725A	98	36	RCP	899.98		0.68	1
725A-725	29	36	RCP	899.68	899.68 899.59	0.15	
725-724	14	36	RCP	899.51	899.4	0.31	
724-723	279	36	RCP	899.4	898.62	0.43	1
723-722	54	36	RCP	898.62		0.28	
722-721	60	42	RCP		898.45	0.31	-2
721-720	132	42	RCP	898.42 898.11	898.13	0.48	3
720-719	80	42	RCP		897.67	0.33	4
733-732	29	42	RCP	897.64	897.25	0.49	-1
732-723	29	12	RCP	903.79	903.56	0.79	
736-730	25	15		903.48	903.21	1.08	
731-730	27		RCP	903.35	903.19	0.59	
729-728	175	15	RCP	903.46	903.17	1	
728-727		15	RCP	902.87	901.94	0.53	1
727-726A	174	15	RCP	901.85	900.99	0.49	
	16	15	RCP	900.99	900.83	1	-1
726A-726	29	24	RCP	900	899.88	0.41	

690-689	47	12	RCP	902.47	902.08	0.83	1
689-688	108	12	RCP	902.08	901.55	0.51	
688-687	55	12	RCP	901.45	901	0.51	
687-686	134	12	RCP	900.97	899.18	1.34	
686-685	61	15	RCP	899.15	898.16	1.62	-5
691-687	29	12	RCP	901.34	901	1.17	
700-696	43	12	RCP	903.65	903.41	0.56	1
657-655	29	12	RCP	900.86	900.55	1.07	
655-654	27	12	RCP	900.23	900.09	0.52	
654-644	127	12	RCP	900.09	899.65	0.35	
659-658	25	12	RCP	900.19	899.97	0.88	
658-645	54	12	RCP	900.09	899.65	0.35	
656-655	56	12	RCP	900.48	900.23	0.45	1
835-834	29	15	RCP	898.06	898	0.21	
834-811	17	18	RCP	898	897.94	0.35	-1
811-810	28	30	RCP	895.3	895.11	0.68	-5
827-818	217	18	RCP	900.12	899.14	0.45	-1
818-817	99	21	RCP	898.93	898.47	0.24	
817-816	118	24	RCP	897.91	897.63	0.24	3
816-815	103	24	RCP	897.61	897.21	0.39	-2
815-814	68	24	RCP	897.17	896.88	0.43	
814-813	47	24	RCP	896.85	896.67	0.38	
813-812	64	30	RCP	896.57	896.34	0.36	-1
812-811	137	30	RCP	896.26	895.3	0.55	-1
821-820	11	15	RCP	899.89	899.71	1.64	
820-819	54	18	RCP	899.66	899.57	0.17	
819-818	81	21	RCP	899.5	899.09	0.51	-1
847-819	11	12	RCP	900.06	899.64	3.82	
653-643	29	12	RCP	900.72	900.61	0.38	
836-817	62	15	RCP	899.52	899.21	0.5	
730-729	55	15	RCP	903.11	902.98	0.24	

RCP Pipe Totals:

	12	1946
	15	1751
	18	1443
	21	691
	24	1207
	27	73
	30	229
	36	474
	42	272
Total:		8086

The length of the drain due to the changes described above is now 8086 feet.

The non-enforcement was approved by the Board at its meeting on March 27, 2006and recorded under instrument #200500041 and #200600019145.

The following sureties were guaranteed by Bond Safeguard Insurance Company and released by the Board on its February 9, 2007 and October 8, 2007 meetings.

Bond-LC No: 5016989 Insured For: Storm Sewers Amount: \$494,825 Issue Date: July 8, 2005

Bond-LC No: 5016990 Insured For: Erosion Control Amount: \$67,200 Issue Date: July 8, 2005

Bond-LC No: 5018858 Insured For: Erosion Control Amount: \$34,800 Issue Date: September 14, 2005


I recommend the Board approve the drain's construction as complete and acceptable.

Sincerely,

Kenton C. Ward, CFM


Kenton C. Ward, CFM Hamilton County Surveyor

KCW/slm

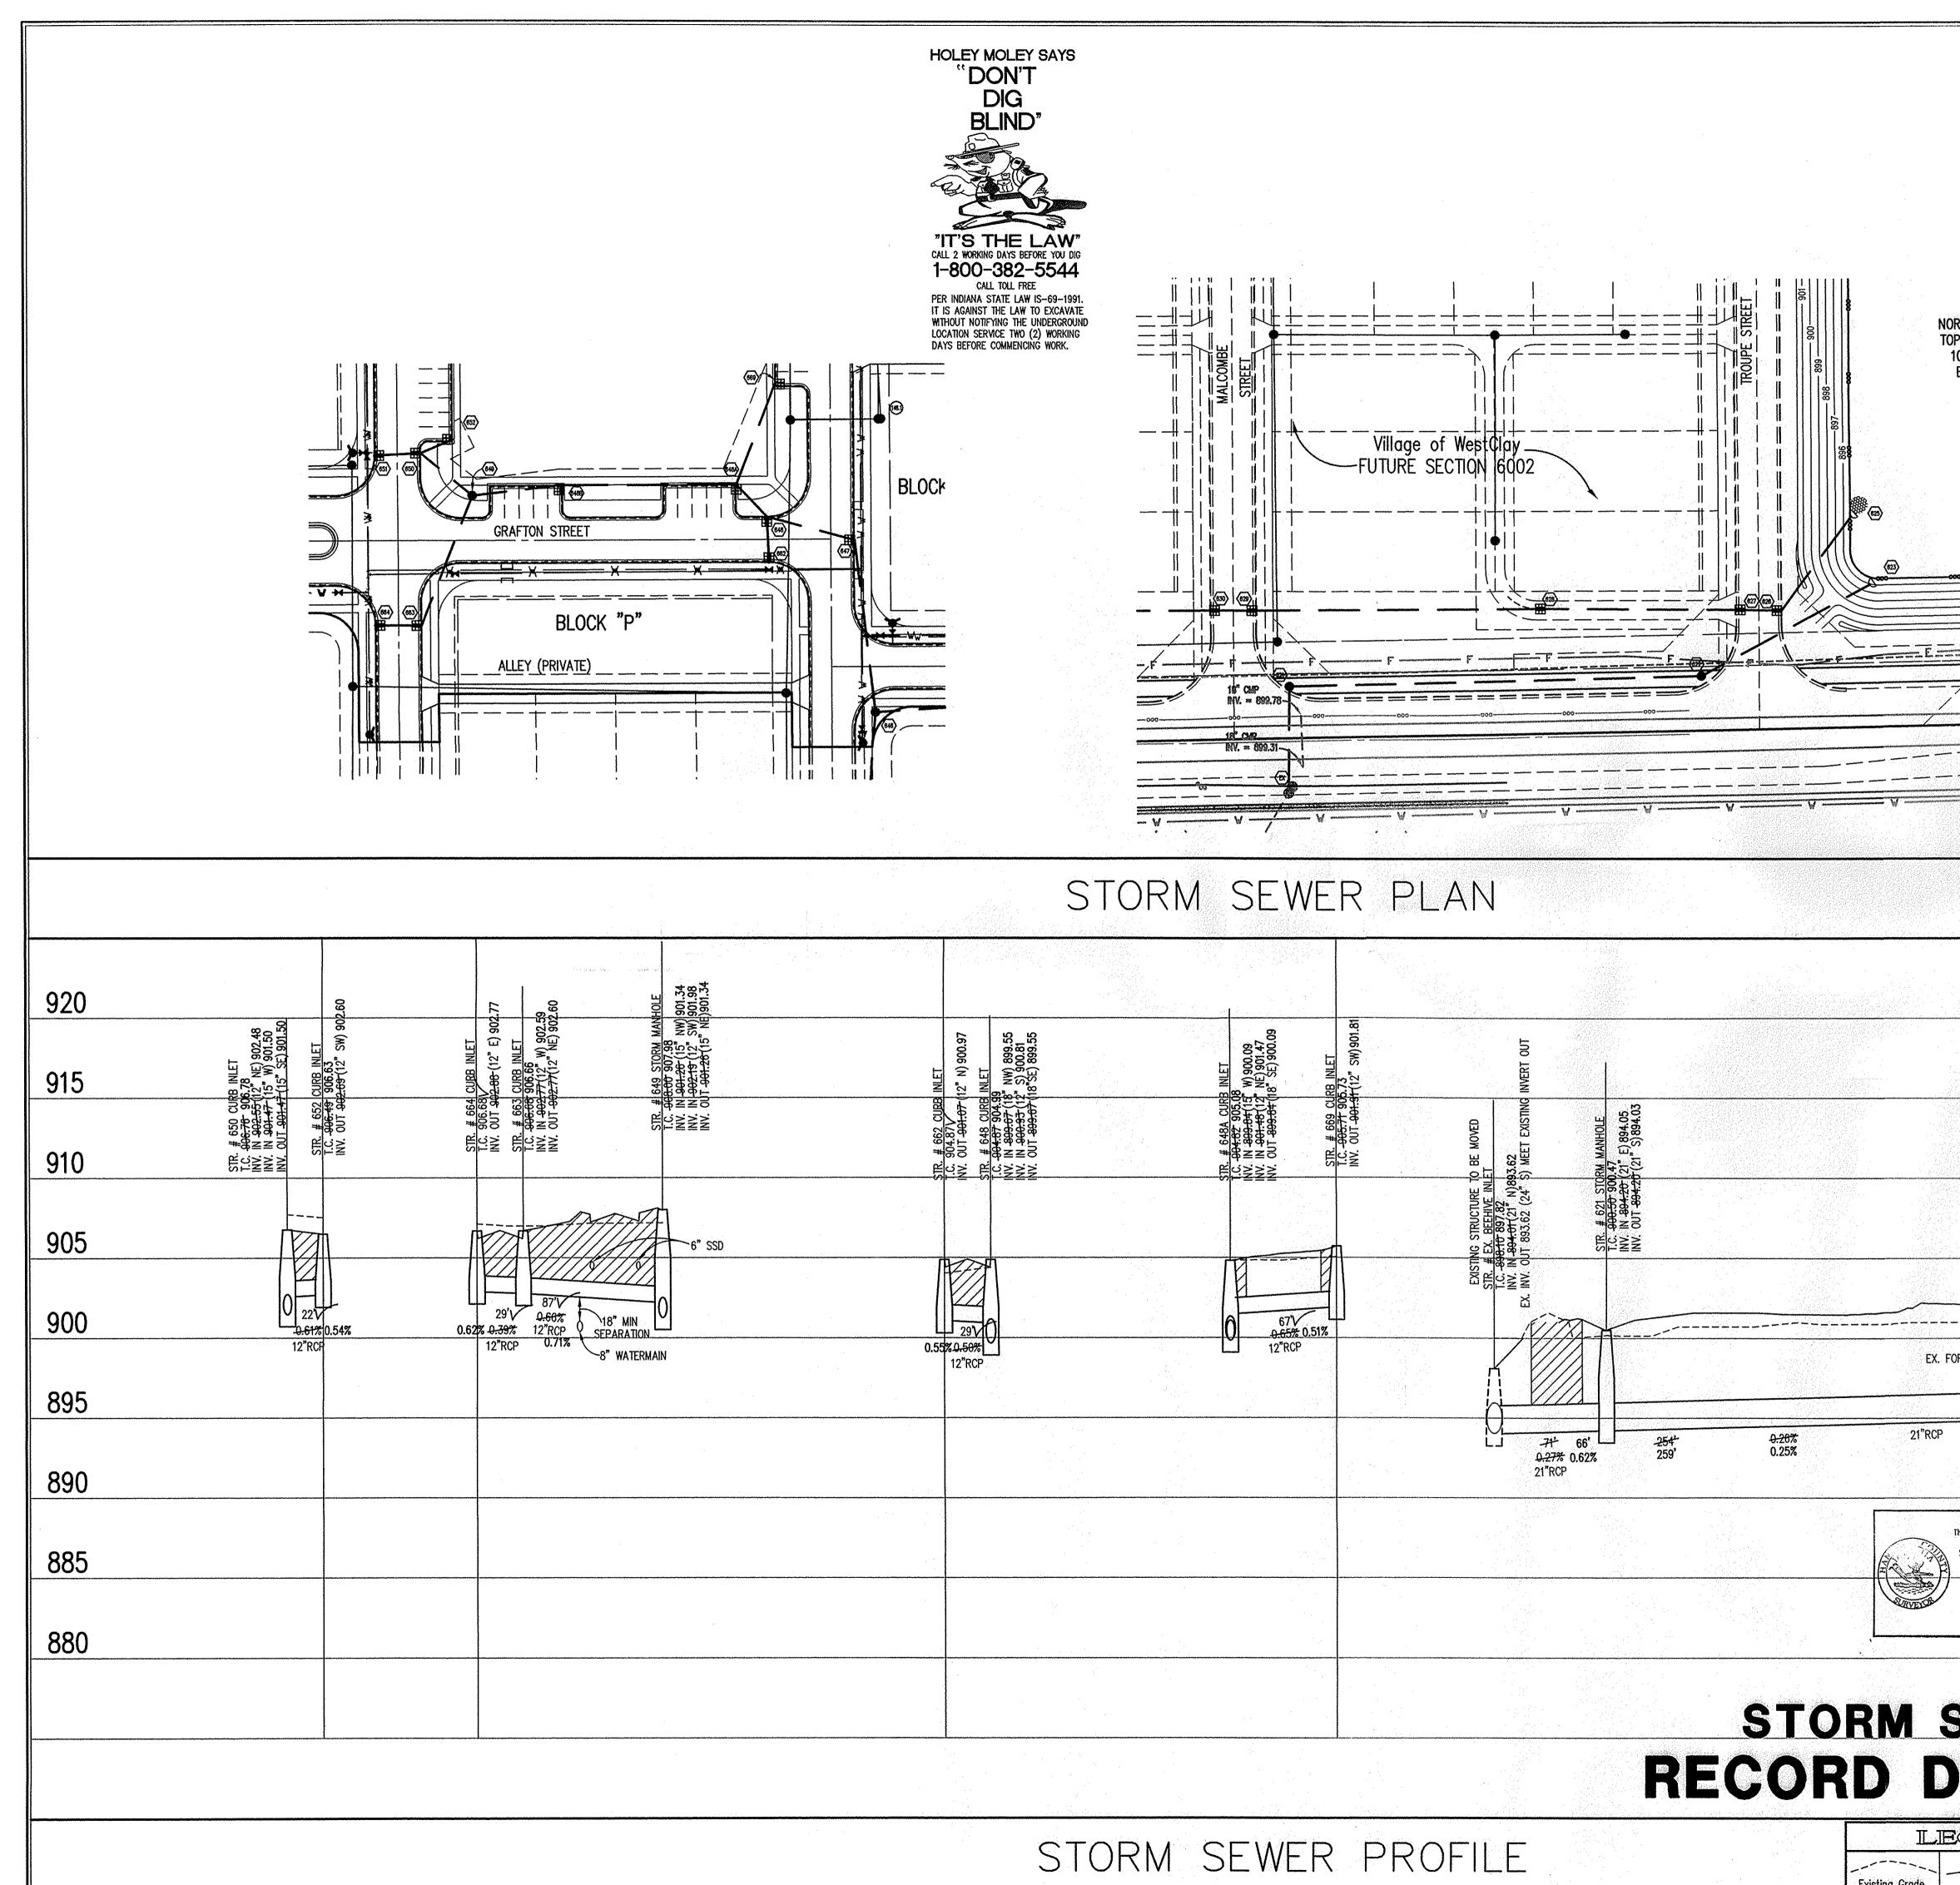



Existing Grade


POND 8 DRMAL POOL=895.2 DP OF BANK=901.7 100 YEAR=899.7 BOTTOM=887.2	Sheet Description C803 1 Bedding Detail - Reinforced Concrete Pipe (RCP) C803 5 Straight Curb Inlet Detail C803 3 Beehive Inlet Detail C803 4 Paved Area Inlet C803 2 Storm Manhole Detail C803 2 Storm Manhole Detail C803 8 Precast Concrete End Section C803 9 RipRap Detail © End Section IE 1 TEMPORARY TRAFFIC CONTROL DURING CONSTRUCTION TO CONFORM TO APPLICABLE LOCAL AND STATE STANDARDS. 1. TEMPORARY TRAFFIC CONTROL DURING CONSTRUCTION TO CONFORM TO APPLICABLE LOCAL AND STATE STANDARDS. 2. ALL CONSTRUCTION ACTIVITY ON THIS SITE TO BE PERFORMED IN COMPLIANCE WITH APPLICABLE 0.S.H.A. STANDARDS FOR WORKER SAFETY. 3. IT SHALL BE THE CONTRACTORS RESPONSIBILITY TO FIELD VERIFY ALL UTILITY LOCATIONS BEFORE CONSTRUCTION BEGINS.	REVISIONS: 1. DCC, 3/29/05: REMSED OUTFALL PIPES 2. DCC, 5/20/05: REMSED PER TAC COMMENTS, AND CLIENT LANDPLAN CHANGES. 3. DCC, 6/30/05; REMSED POND5, POND6, POND8 AND UPDATED SURROUNDING STORM; ADDED ADDITIONAL STORM RUNS NEAR RONALD REAGAN GREEN AND IN MASS GRADING AREA 4. DCC, 7/77/05: ADDED ESMT. AROUND STORM SEMERS PER HCSO COMMENTS. 5. DCC, 10/5/05: ADDED ESMT. AROUND STORM SEMERS PER HCSO COMMENTS. 6. BET, 1/13/06, "RECORD DRAMING"	
	 4. CONTRACTORS SHALL MINIMIZE DAMAGE TO EXISTING TREES. 5. FOR INSTALLATION OF STORM MAINS, WATER MAINS, SANITARY MAINS, WATER SERVICE LATERALS, SANITARY SERVICE LATERALS UNDER CITY STREETS, REGARDLESS OF THE JURISDICTION OF THE UTILITY, THE MINIMUM COVER FROM THE TOP OF THE INSTALLED PAVEMENT TO THE TOP OF THE INSTALLED PIPE SHALL BE THE PAVEMENT SECTION THICKNESS (ALL BITUMINOUS AND AGGREGATE MATERIAL ABOVE THE SUBGRADE) PLUS 1-0°. IF THE STANDARD PRACTICE OF THE UTILITY THAT HAS JURISDICTION OVER THE INSTALLATION HAS A MORE STRINGENT COVER REQUIREMENT, THE MORE STRINGENT REQUIREMENT SHALL GOVERN. TEMETOR CHEMICATION FRANK CUT "X" NORTH BONNET BOLT IN FIRE HYDRANT EAST SIDE HOOVER RD. ±100' SOUTH OF CLARIDGE FARM ENTRANCE. ELEVATION – 893.39 	BLANDON 7. BU BANDON 7. BU BANDON 7. BU BANDON 7. BU No. 10000075 STATE OF NDIANA STATE STATE NDIANA STATE STATE NDIANA STATE STATE NDIANA STATE OF NDIANA STATE OF NDIANA STATE OF NDIANA STATE OF NDIANA STATE STATE NDIANA STATE STATE NDIANA STATE STATE NDIANA STATE STATE NDIANA STATE STATE NDIANA STATE STATE NDIANA STATE STA	ESIGNS AND THE EXCLUSIVE SCHNEIDER BE USED OR IRT, WITHOUT SCHNEIDER
	SCALE: 1"=50' 920 915	THE SCHNEIDER CORP 12821 E. New Market Suite 100 Carmel, IN 46032 Telephone: 317.569.81 Fax: 317.826.6410 www.schneidercorp.com Architecture Civil Engineering Environmental Enginee Geotechnical Services GIS * LIS Home Builder Services Interior Design Land Surveying Landscape Architectur Transportation Enginee	ORATION Street 112 n ering
STR. # 622 STORM MAN STR. # 622 STORM MAN I.C. 301.70 901.63 INV. IN 204.67 (15" W) INV. OUT 204.67 (21" W) EXE. # 623 END SECTION 0117 BALE 30415 SWI 805 11	910 905 900	WestClay N 6001 INDIANA	DEVELOPMENT CO. Mel, indiana
This information was gathered for input into the Hamilton County Geographic Information System (GIS). This document is considered an official record of the GIS. Entry Date: 2-31-07	NORMAL POOL ELEV=895.20 895 890 885	Village of WestC SECTION 6001 CARMEL, INDIANA	BRENWICK DEVEL(CARMEL, IND
Entry Date:	880	DATE: 3/1/05 12 DRAWN BY: DCC SHEET TITLE: STORM SEWEH PLAN & PROFI DRAWING FILES: N: \1238\6001-BS.DWG XREF: 6001-BS.DWG XREF: 6003-BS.DWG XREF: 6003-BS.DWG XREF: CA21.DWG XREF: STORM.DWG	38.6001) BY: R LE
SCA	LE: HORZ.: 1"=50' VERT.: 1"=5'	SHEET NO.:	D11

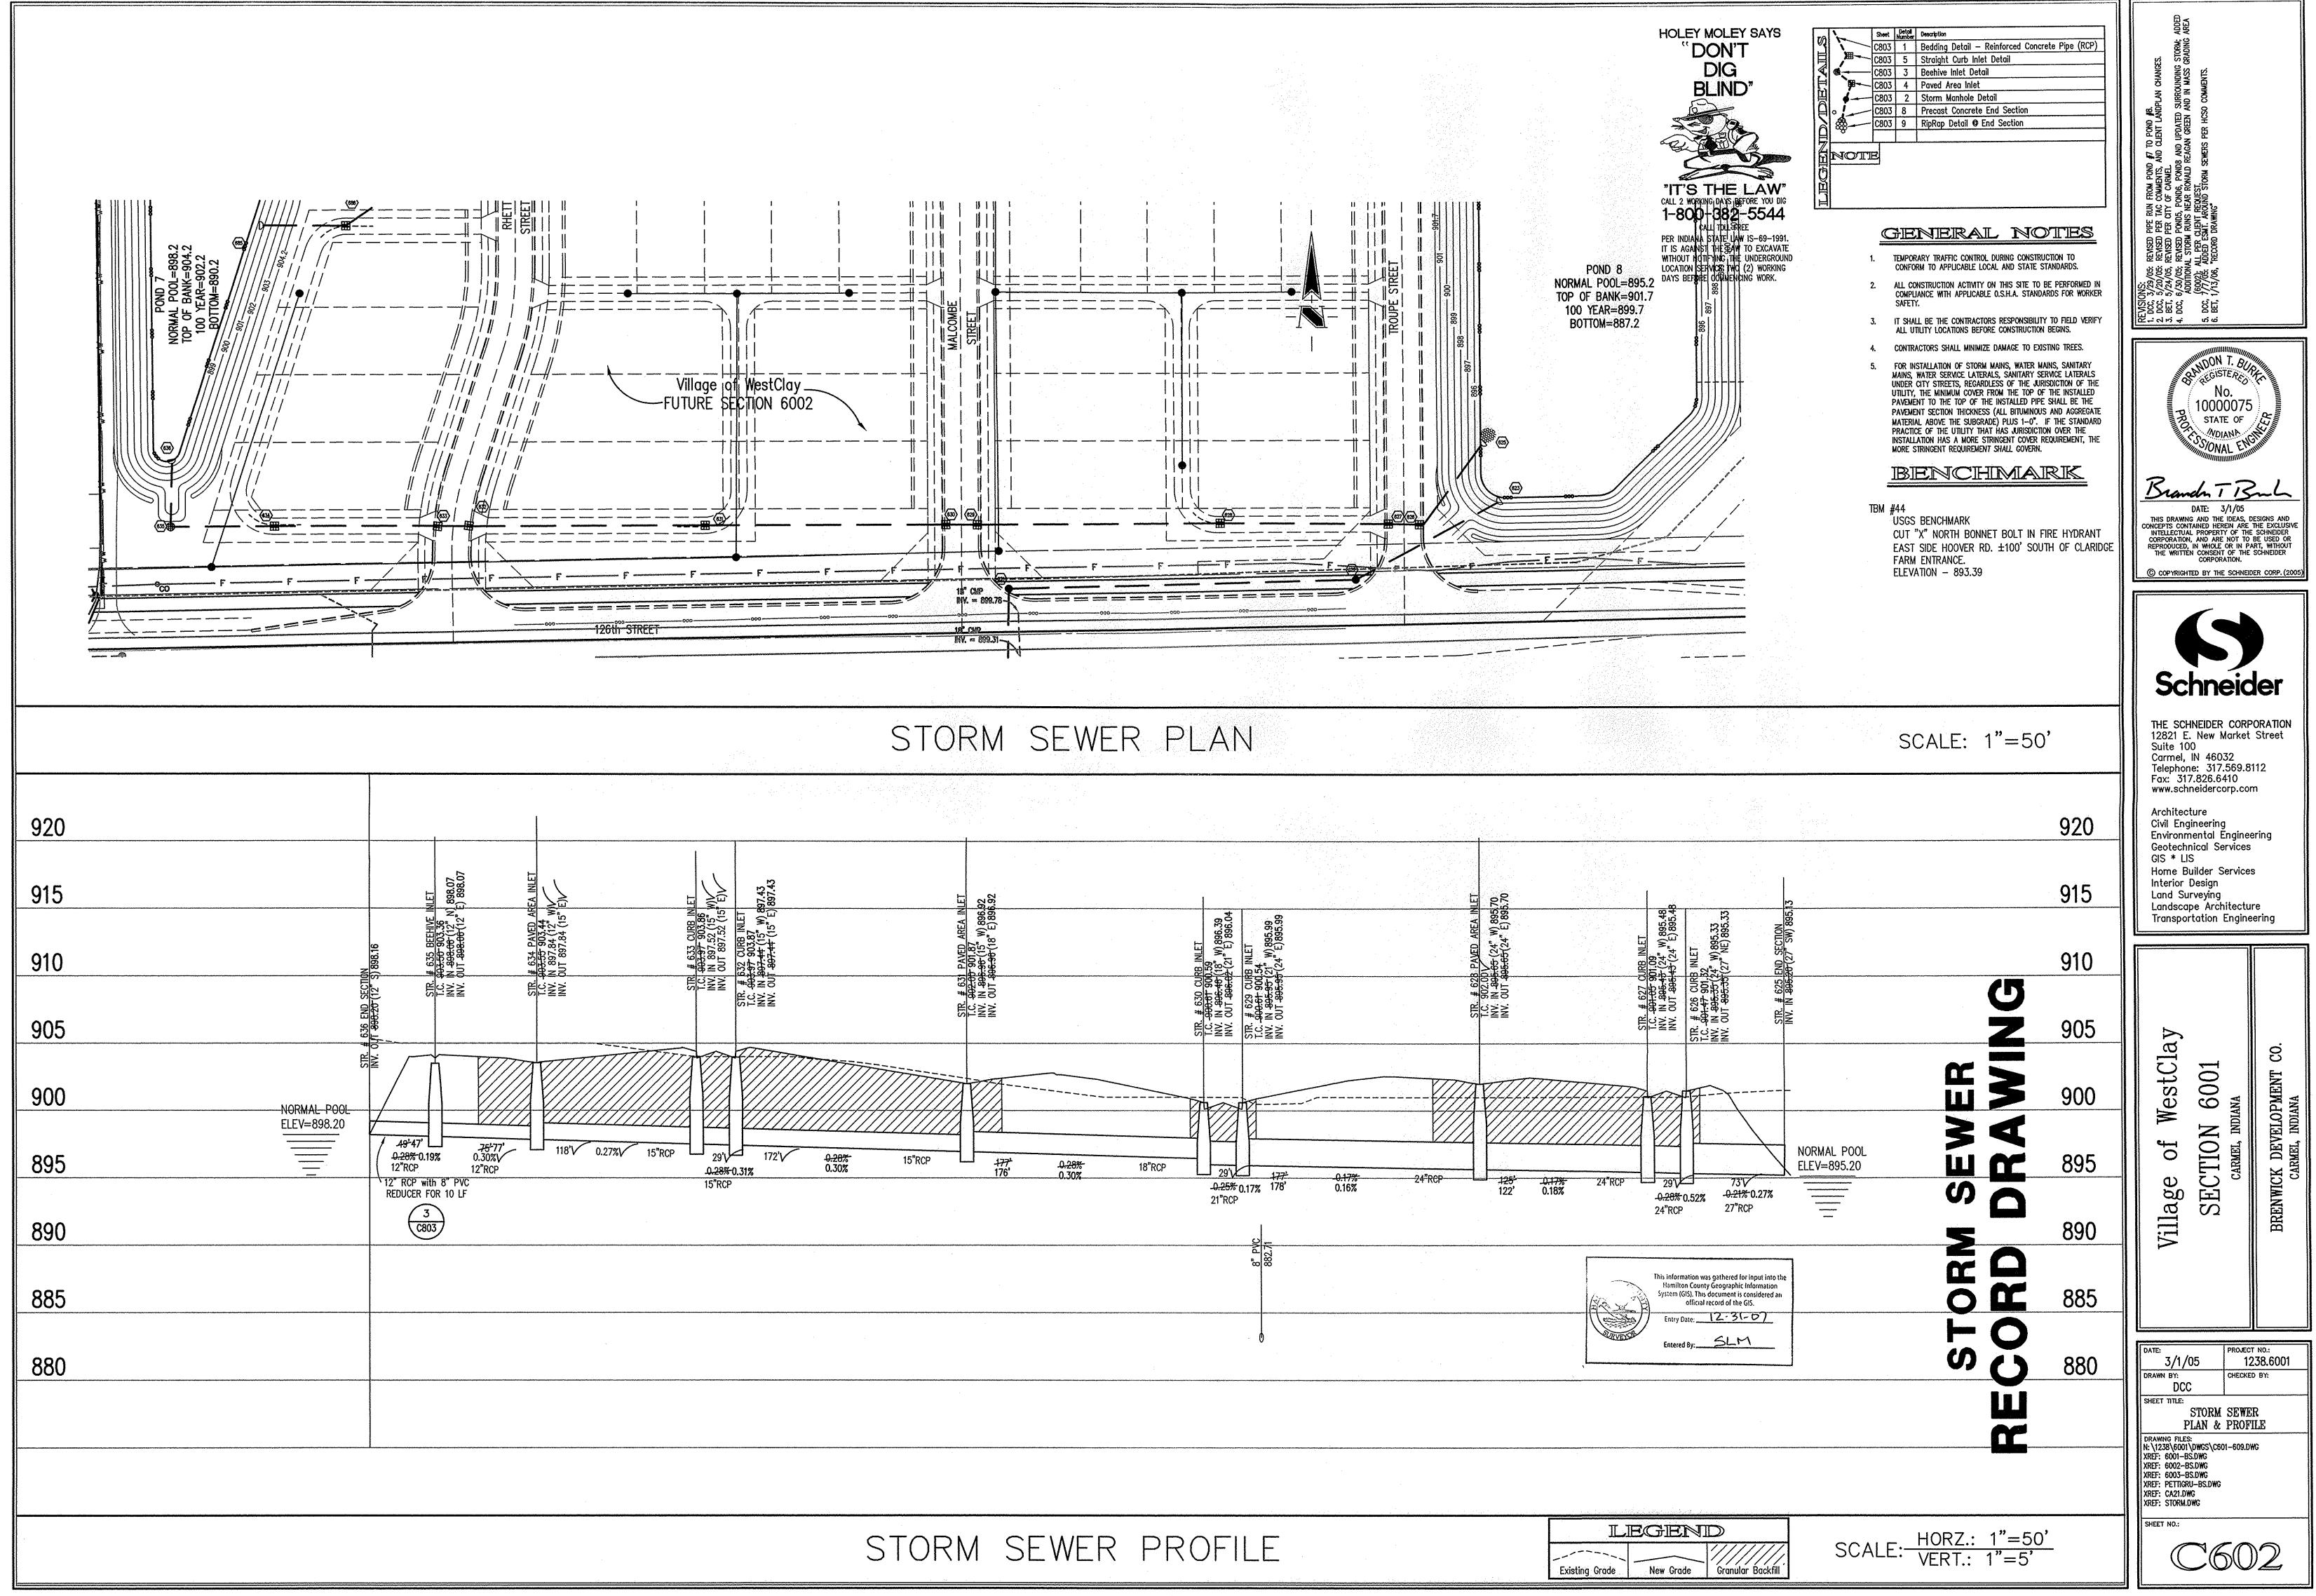



	CERTIFICATION FOR "RECORD Branch T.B.L. CERTIFIED BY: THE SCHNEIDER CORPORATION 12821 EAST NEW MARKET STREET, SUITE 301 CARMEL, INDIANA 46032 (317) 569-8112 FAX (317) 826-6410
	NOTE: Record drawing certification only for top of casting, invert elevations and lengths of pipe. Slope percentage represents a calculated figure and is for general information only.
920	
915	
910 905	
900	
895	
890	
885	
880	

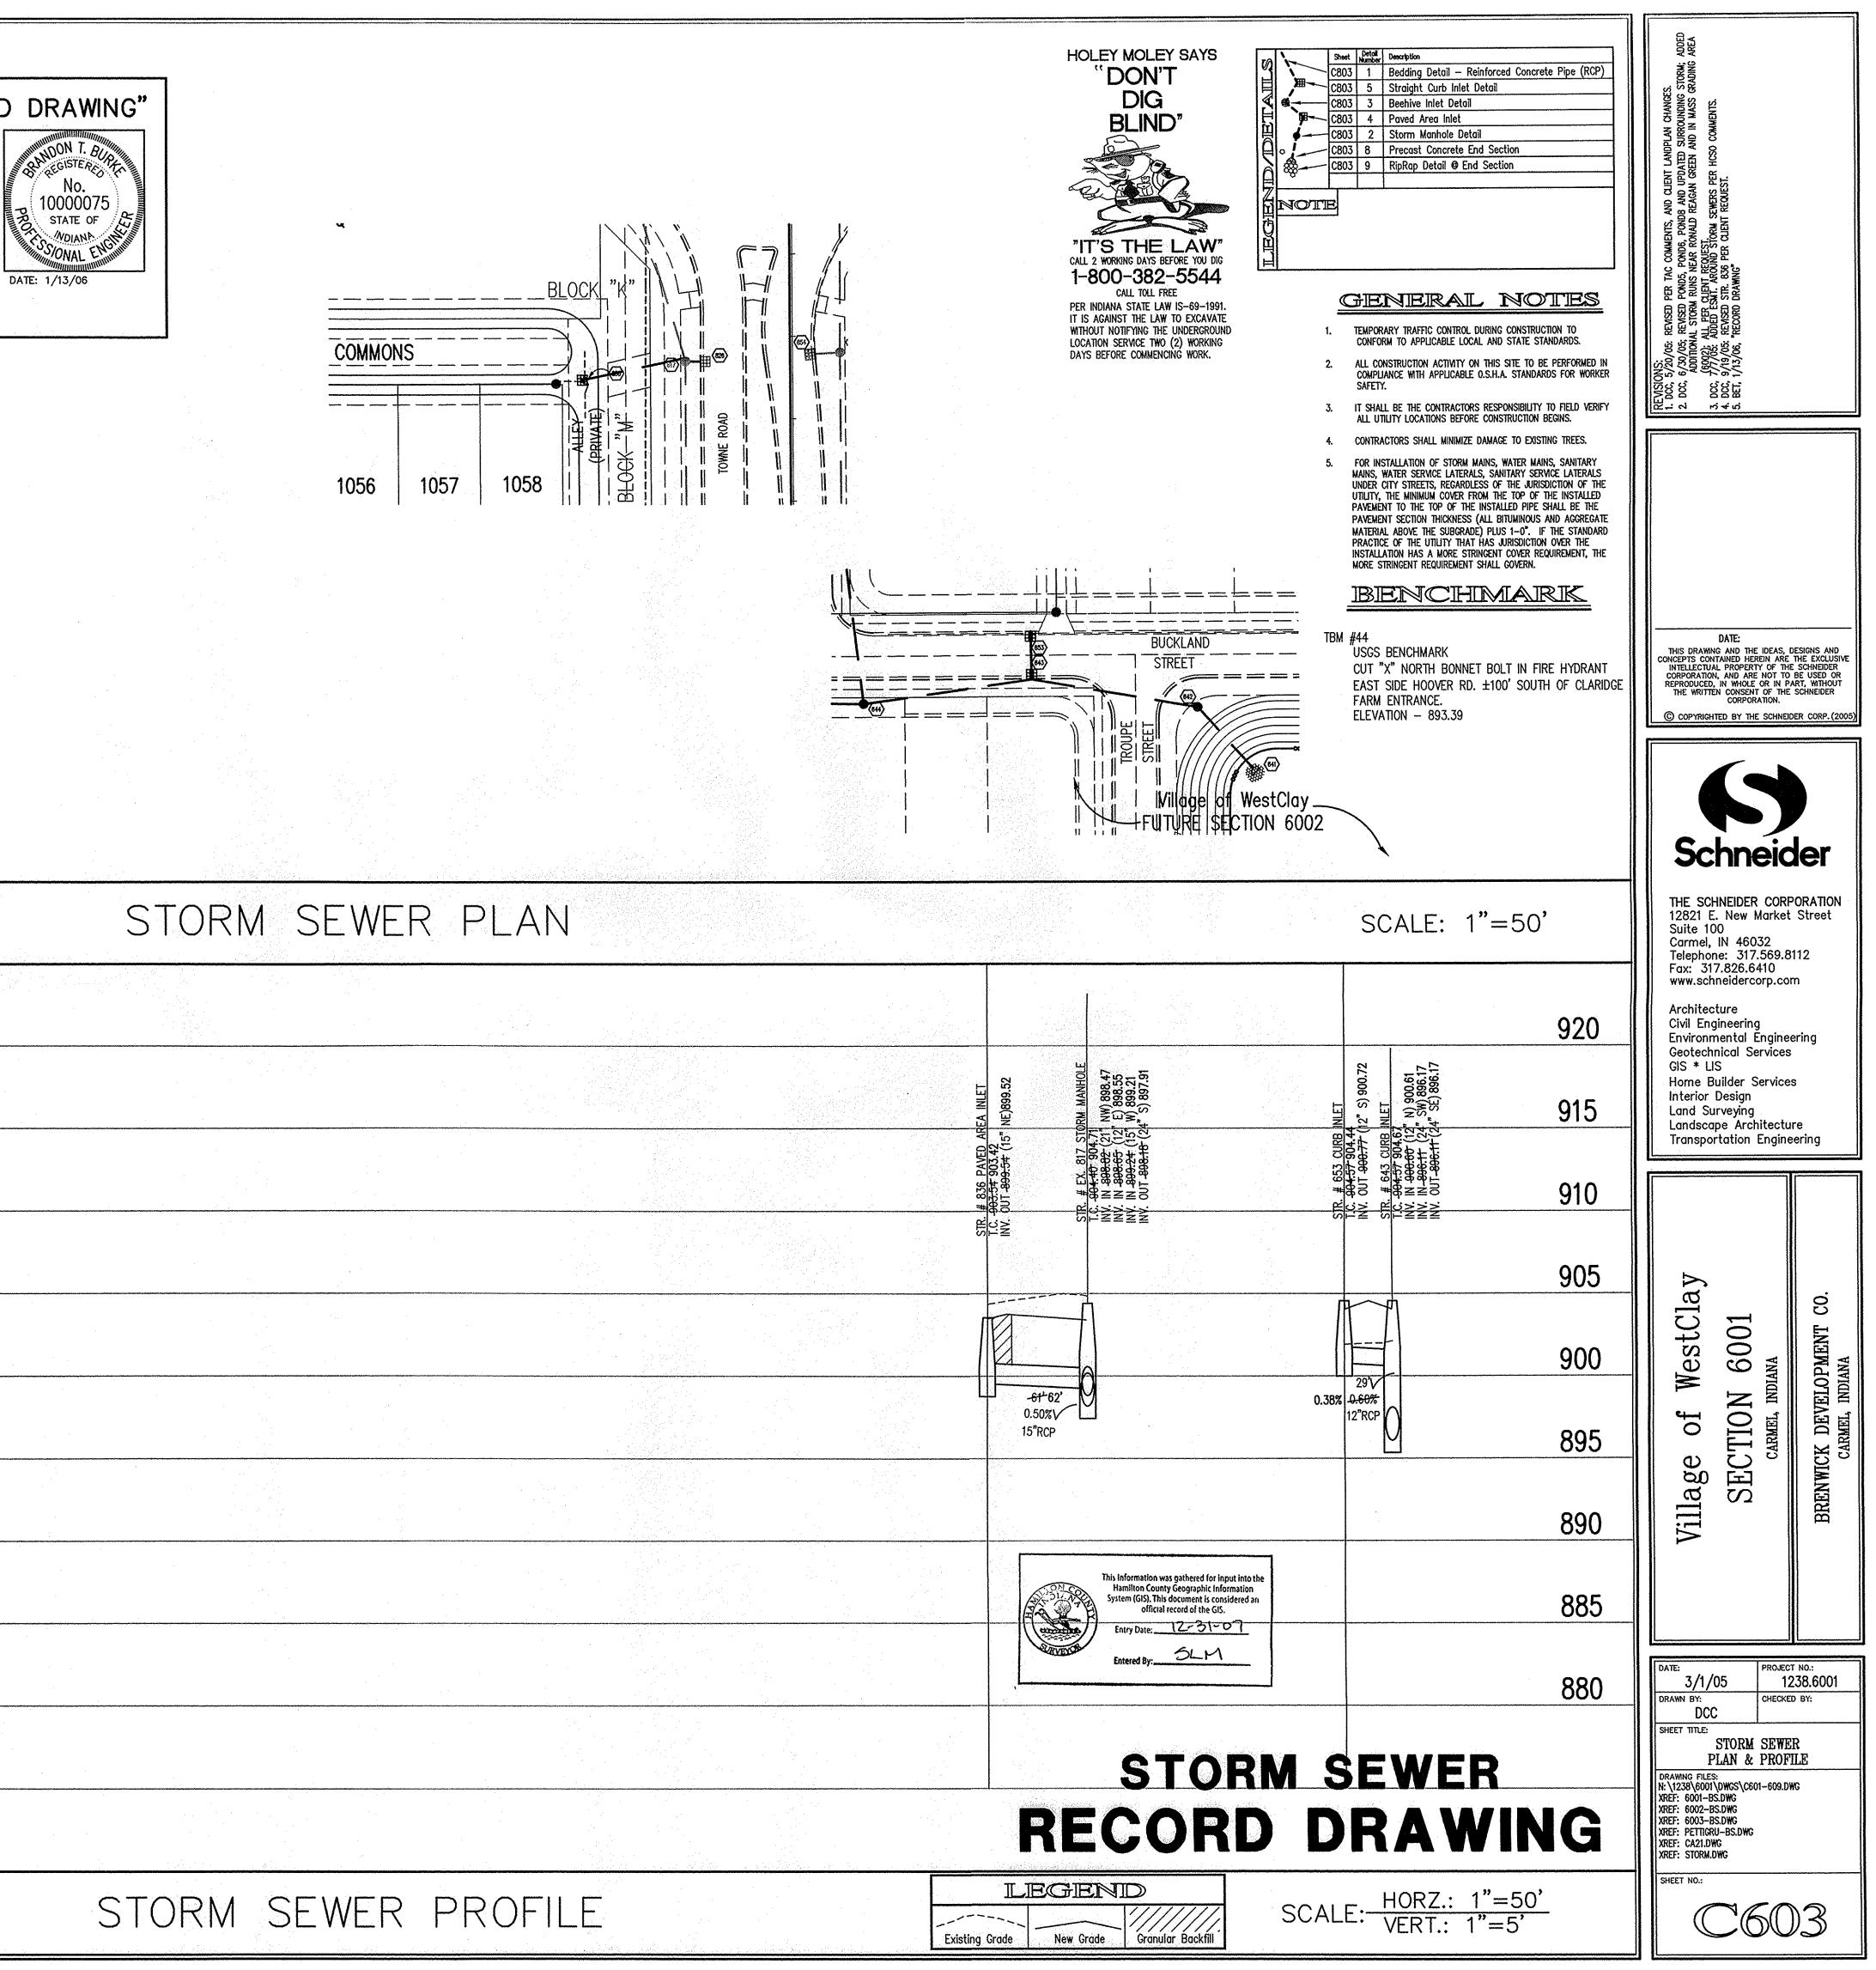

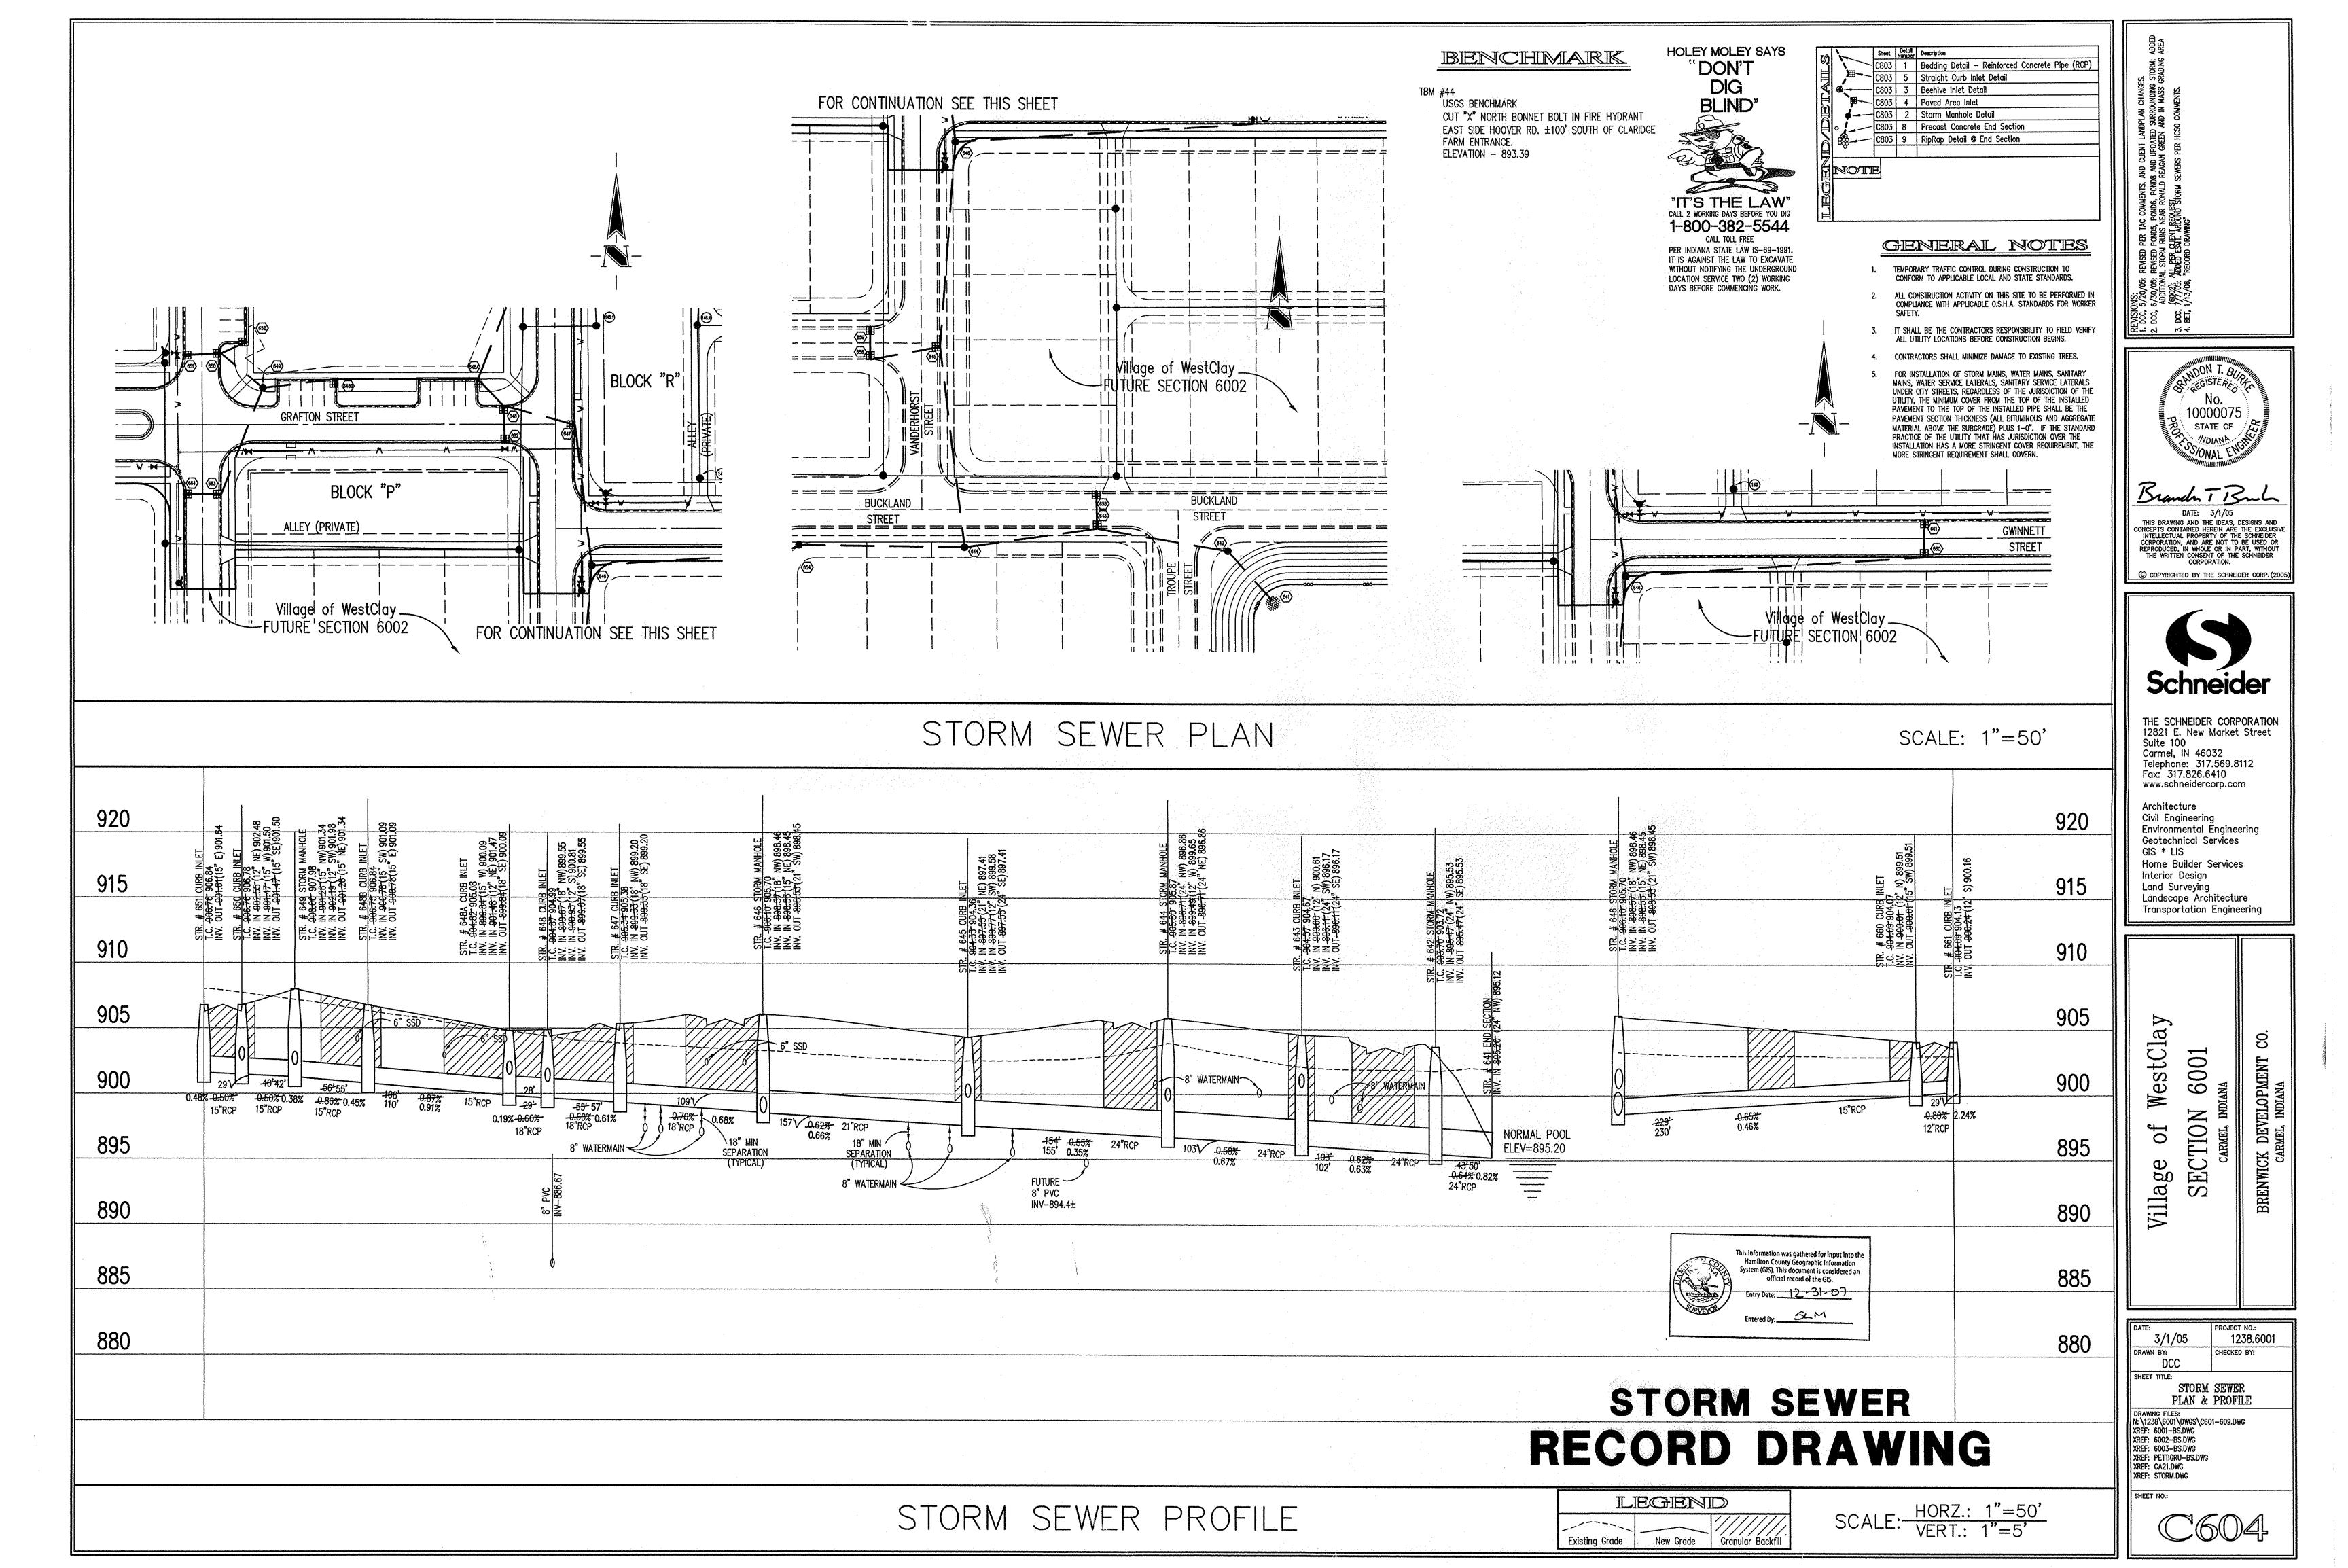

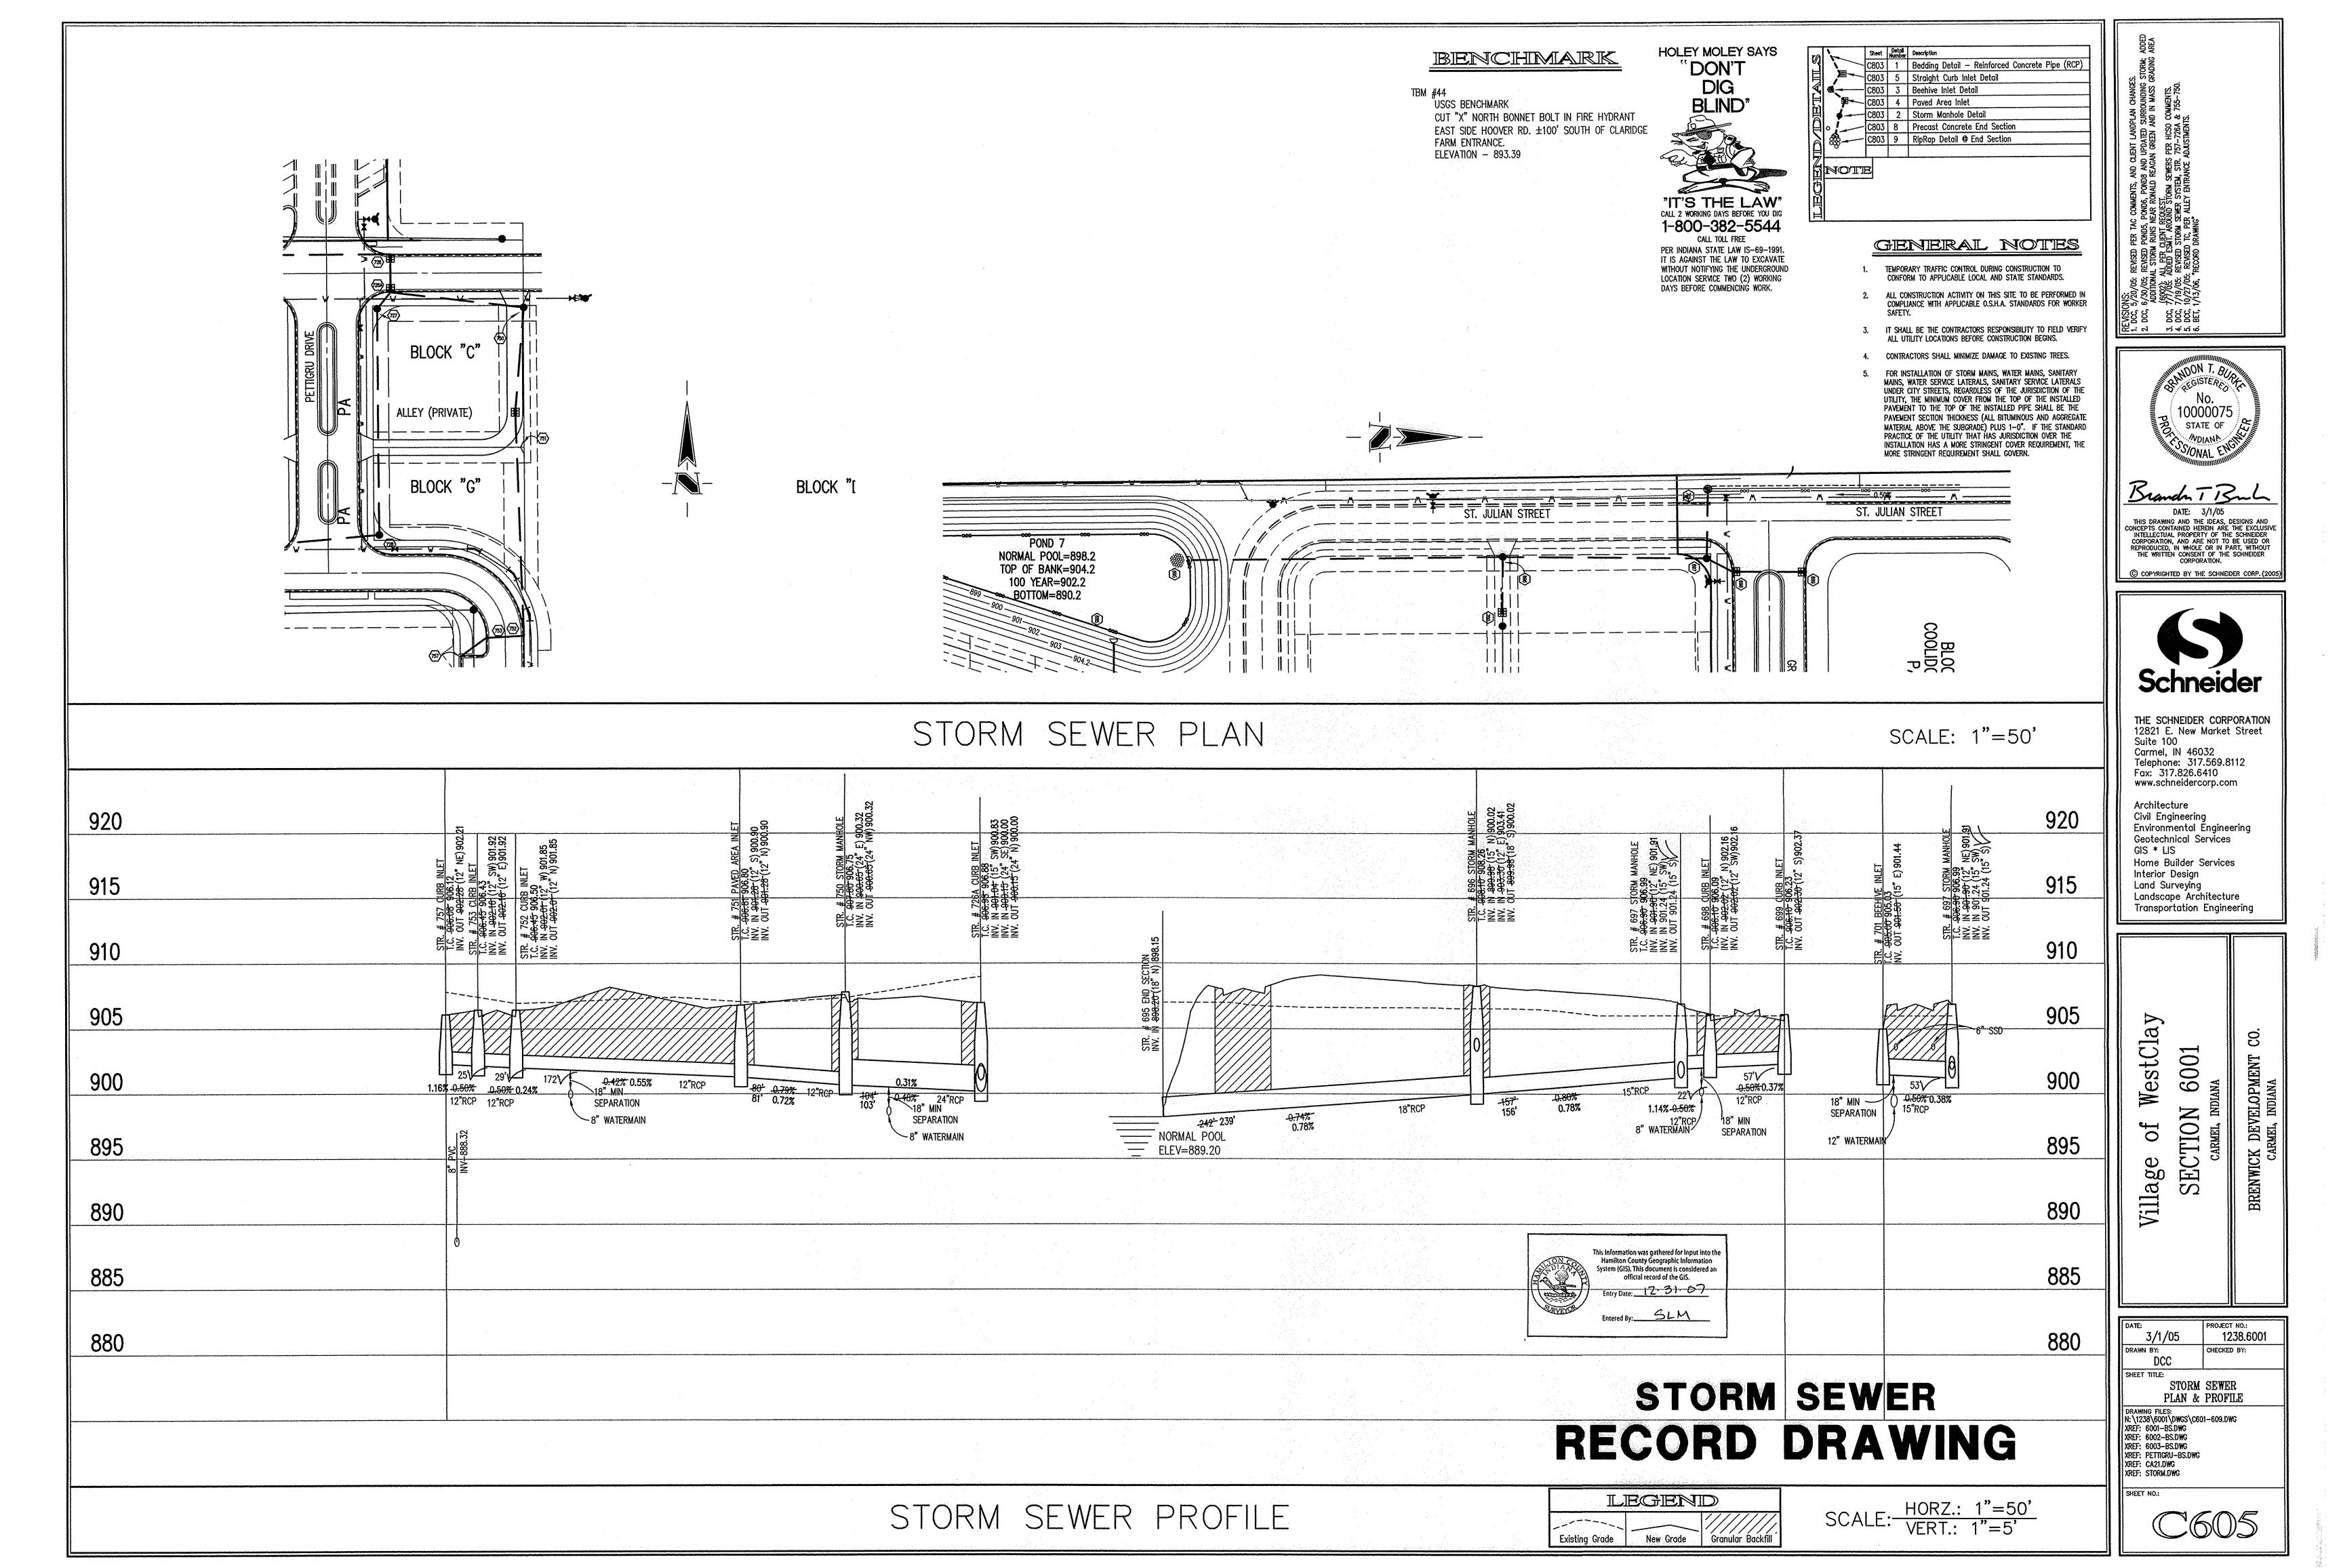


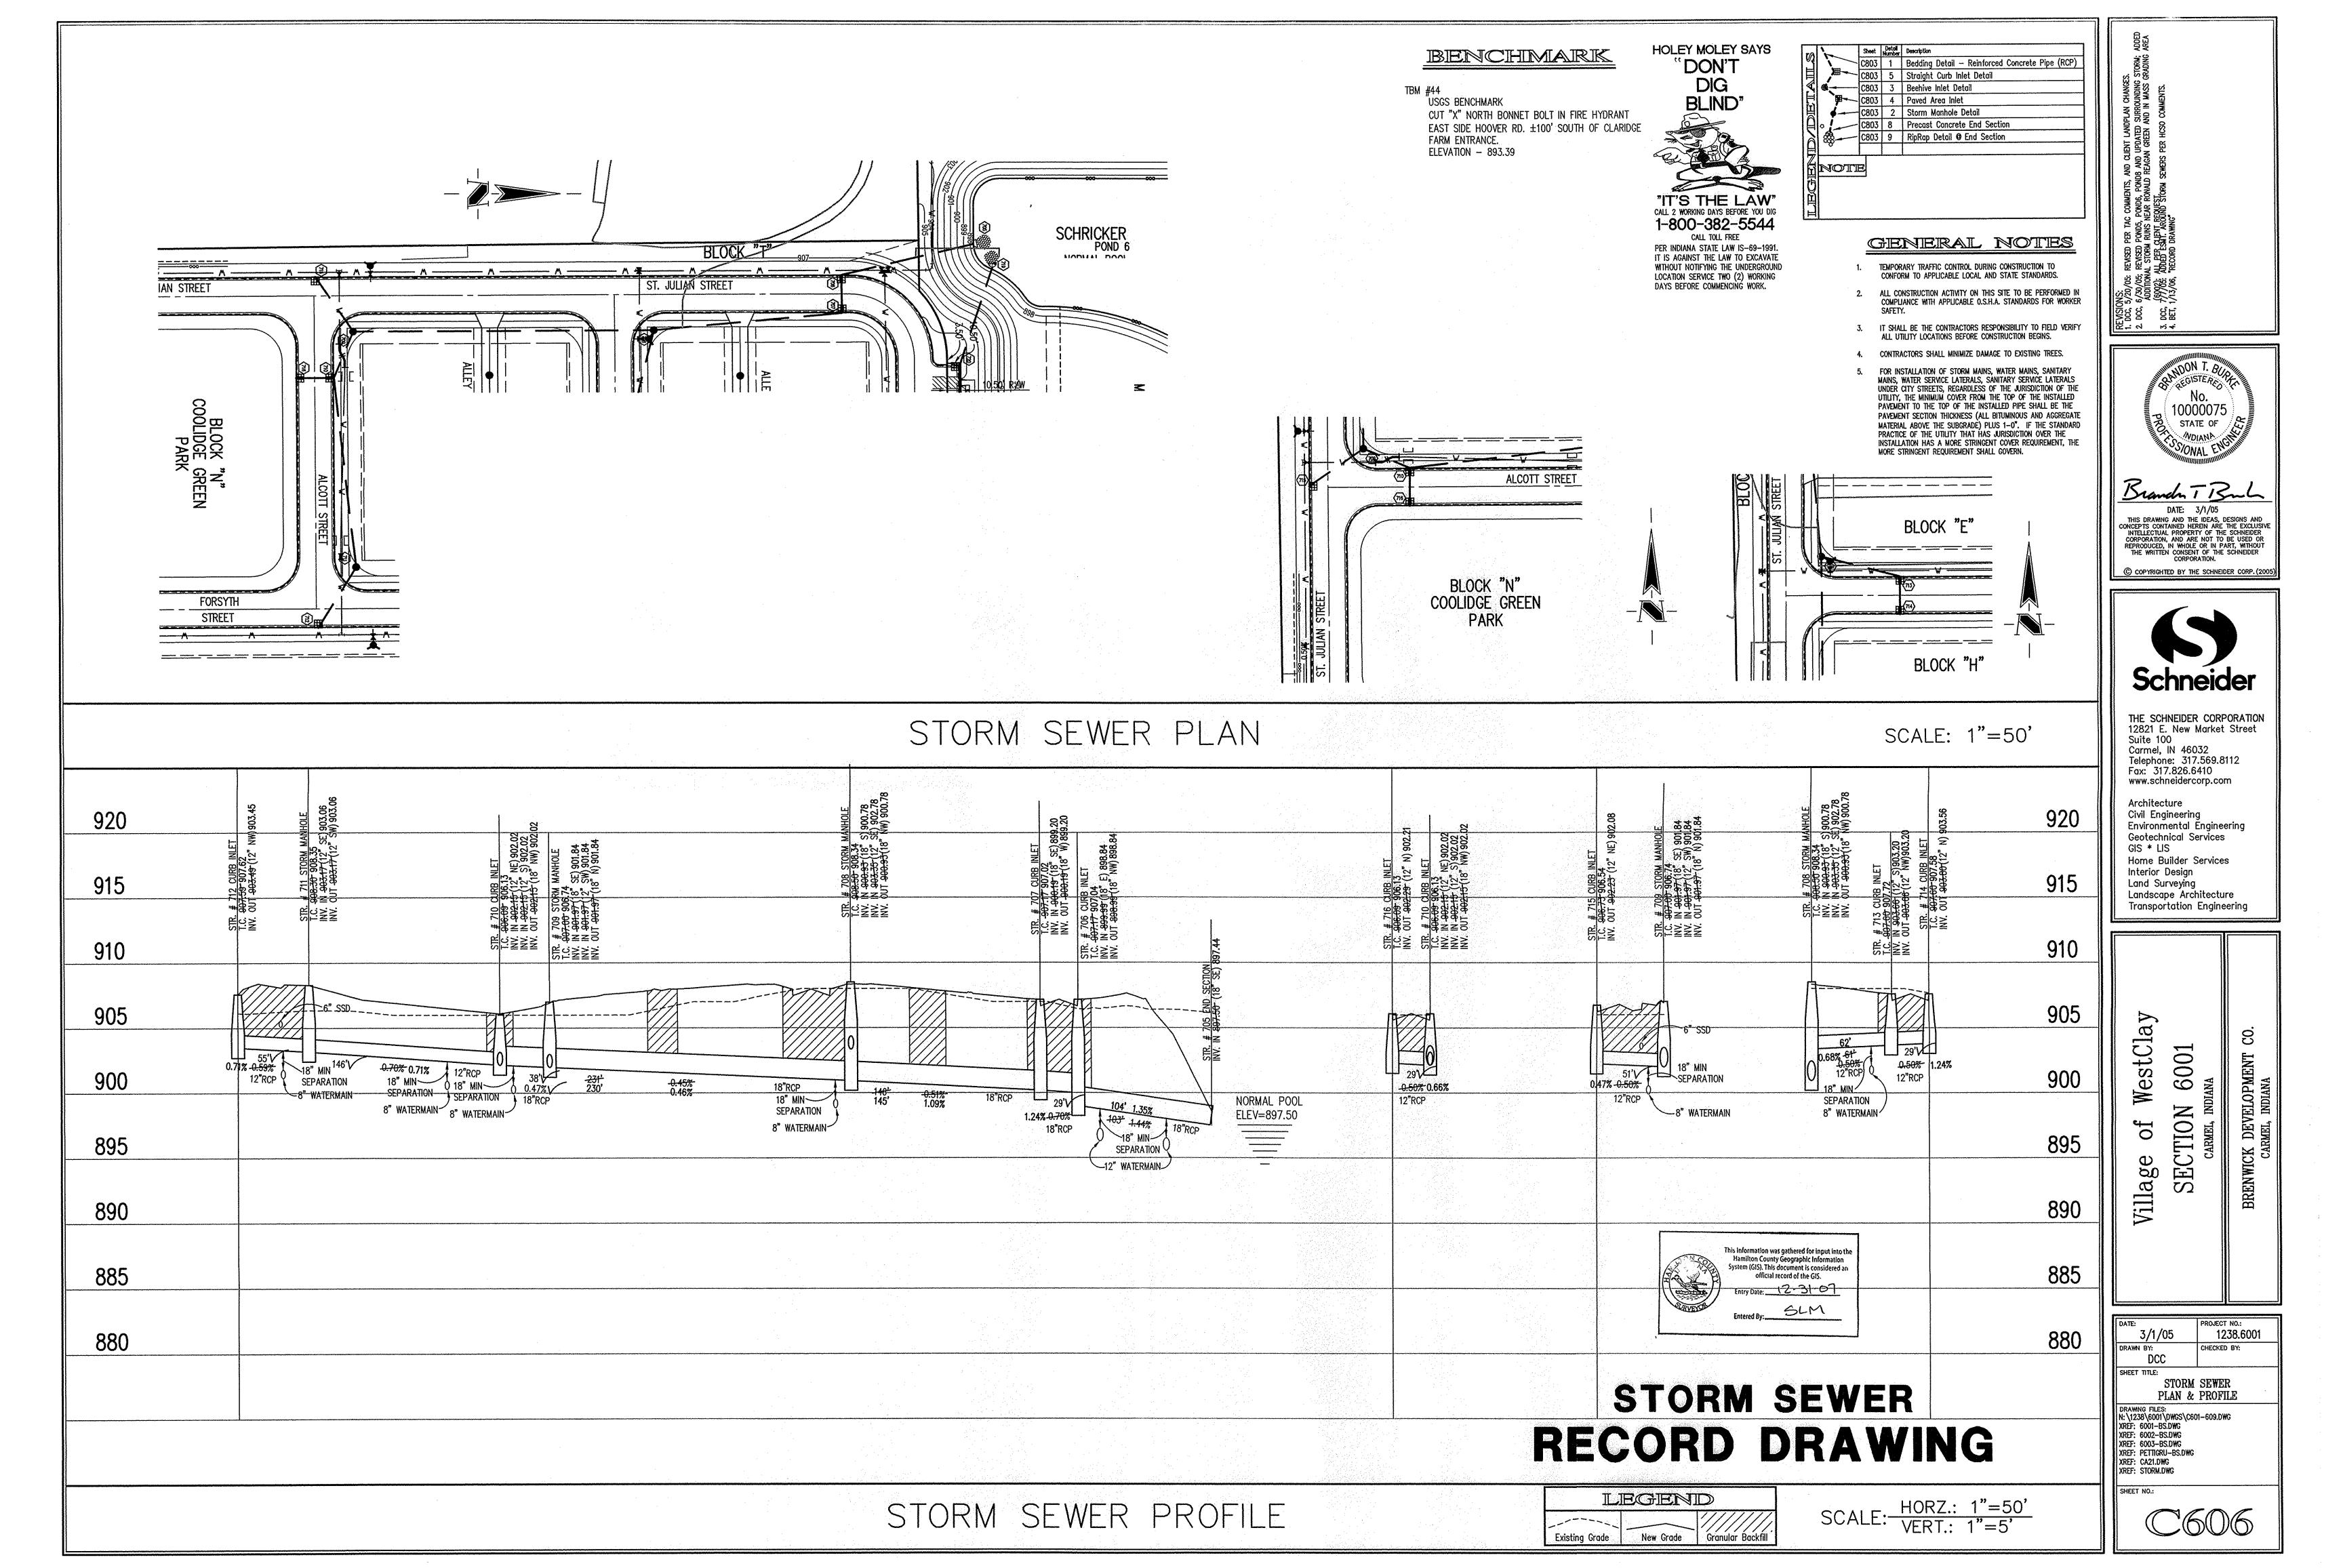

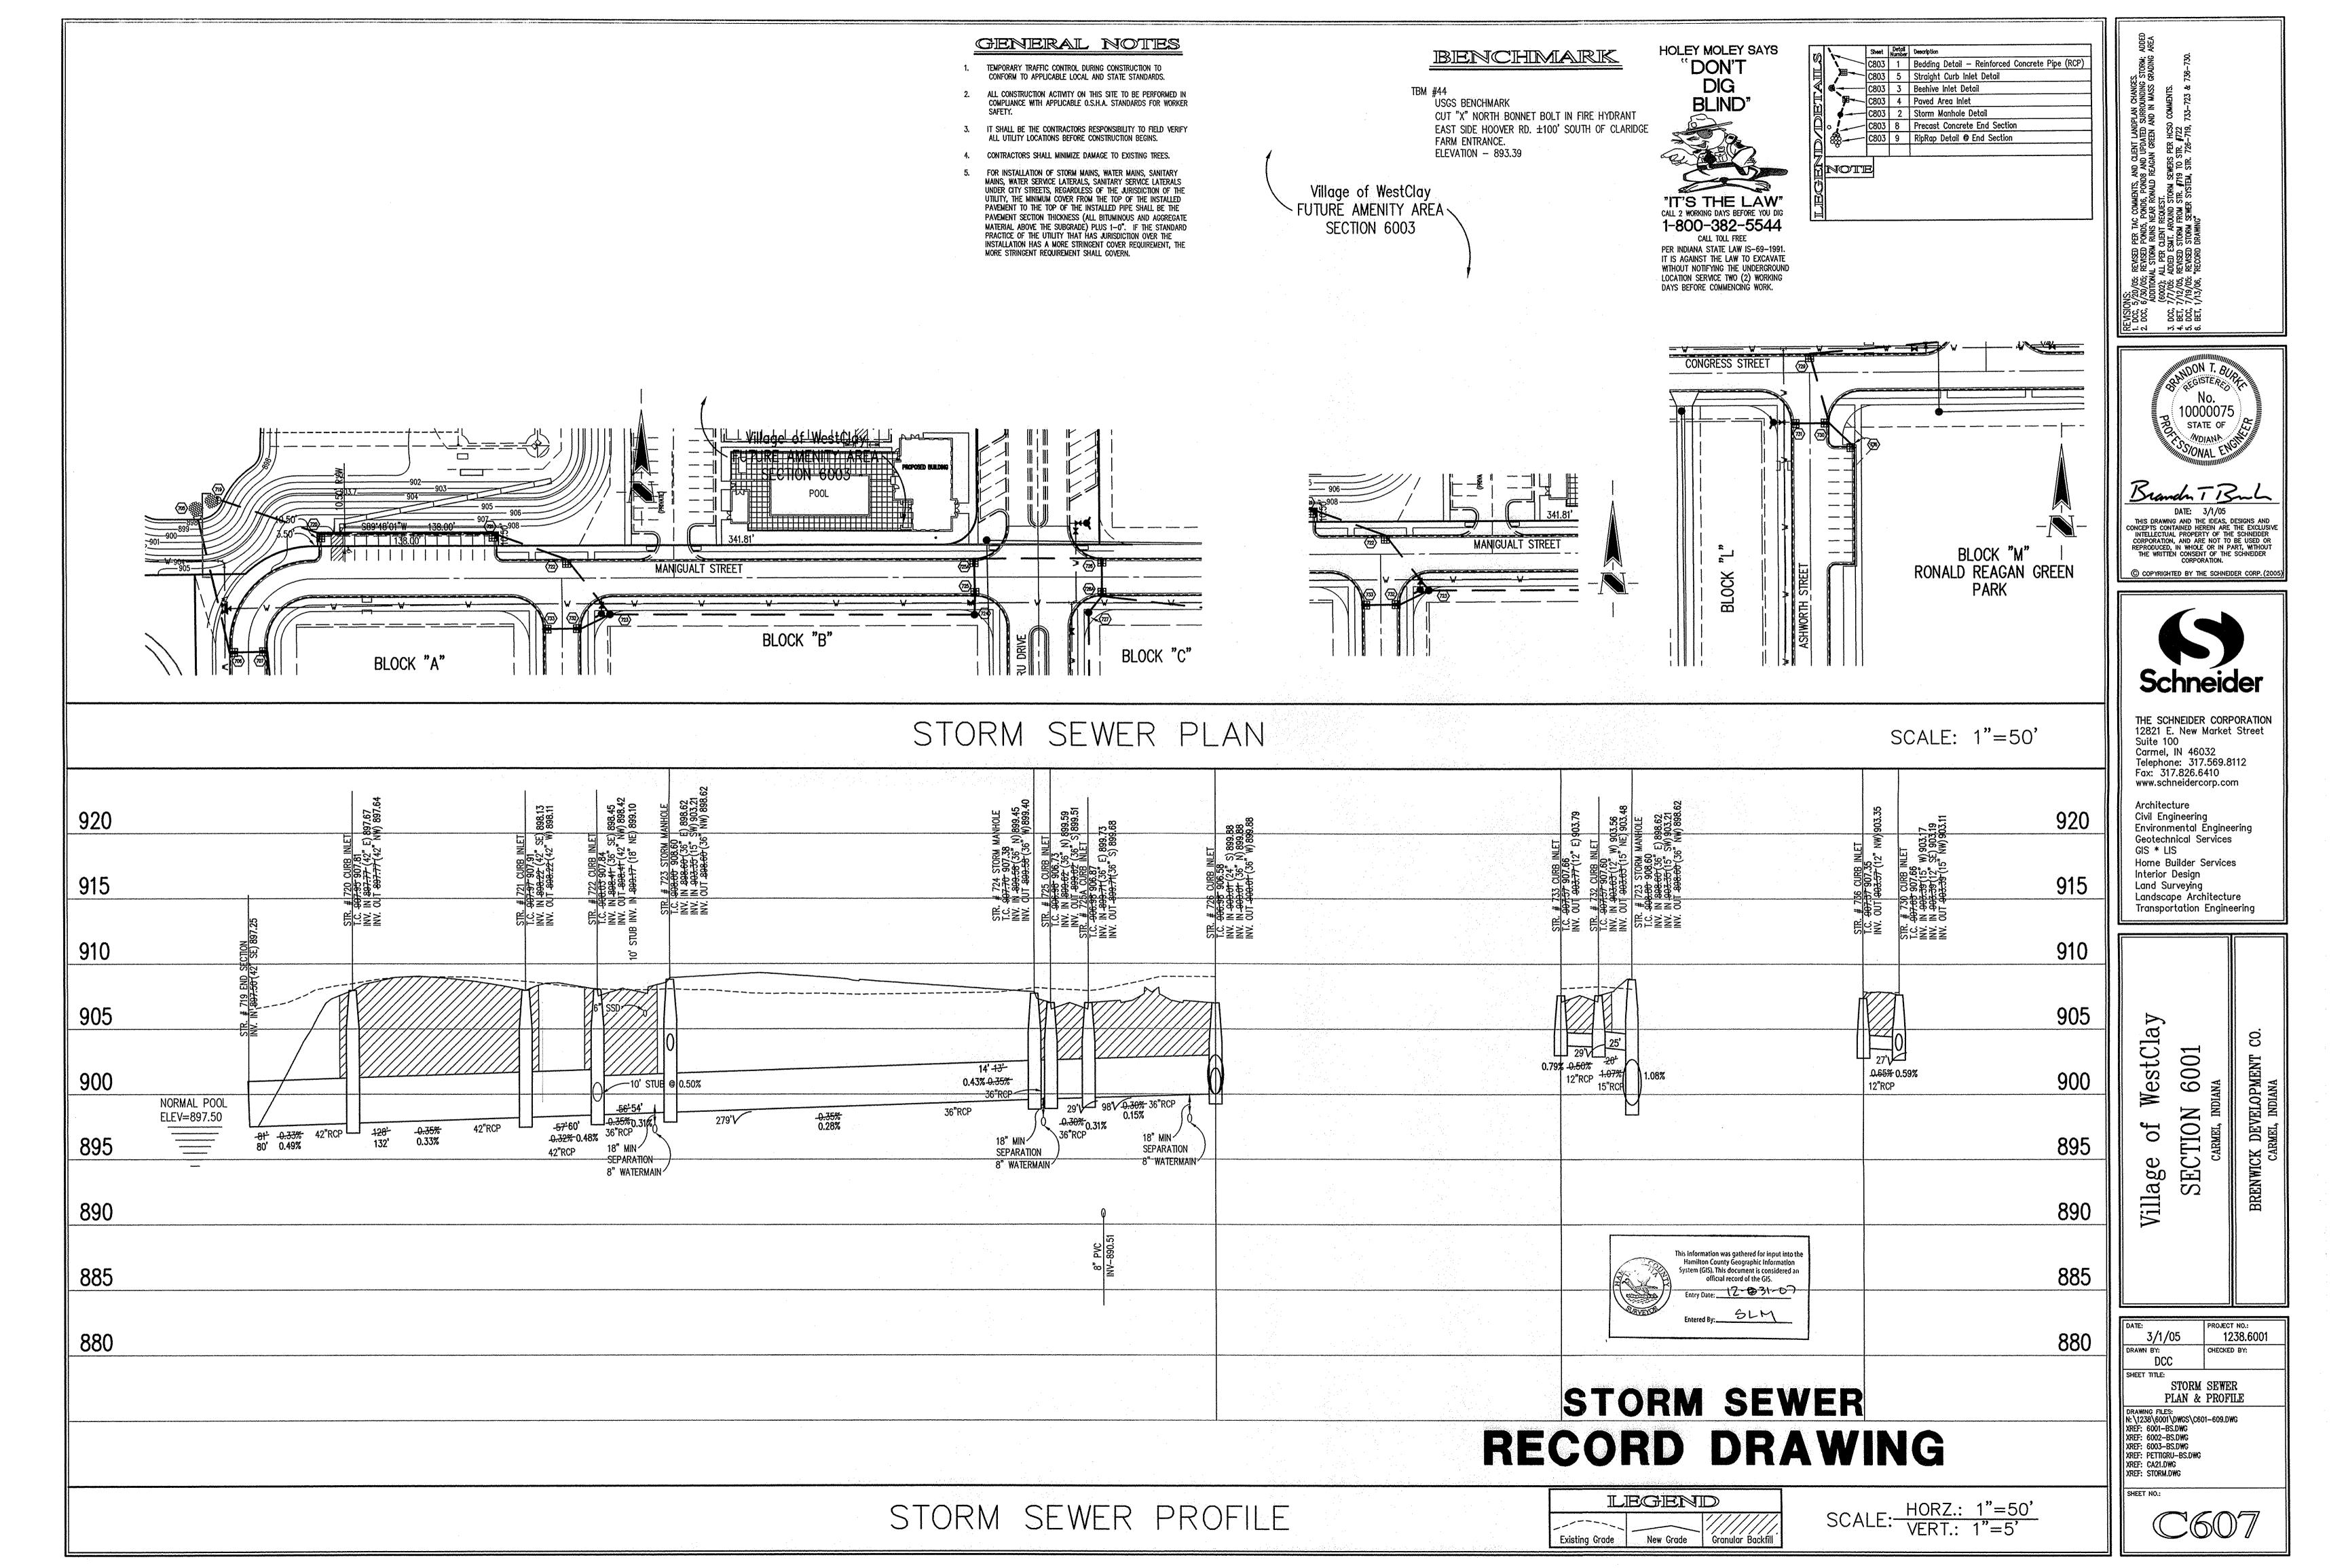


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ENCHMARK NORTH BONNET BOLT IN FIRE HYDRANT DE HOOVER RD. ±100' SOUTH OF CLARIDGE NTRANCE. ON - 893.39	Sheet Description C803 1 Bedding Detail – Reinforced Concrete Pipe (RCP) C803 5 Straight Curb Inlet Detail C803 3 Beehive Inlet Detail C803 4 Paved Area Inlet C803 2 Storm Manhole Detail C803 2 Storm Manhole Detail C803 9 RipRap Detail © End Section C803 9 RipRap Detail © End Section C803 9 RipRap Detail © End Section C9101E	REVISIONS: 1. DCC, 5/20/05: REVISED PER TAC COMMENTS, AND CLENT LANDPLAN CHANGES. 2. DCC, 5/20/05: REVISED POND5, POND8 AND UPDATED SURROUNDING STORN; ADDED ADDITIONLA FICKN RUNS NEAR RONALD REAGAN GREEN AND IN MASS GRADING AREA 3. DCC, 7/19/05: ADDED STORM STORM STORM STREM, STR. 731-726. 5. BET, 1/13/06, "RECORD DRAMING"
"TT'S THE LAW" "A WORKING DAYS BEFORE YOU DIG 1-800-382-5544 CALL TOLL FREE PER INDIANA STATE LAW IS-69-1991. IT IS AGAINST THE LAW TO EXCAVATE WITHOUT NOTIFYING THE UNDERGROUND LOCATION SERVICE TWO (2) WORKING DAYS BEFORE COMMENCING WORK.	UNDER CITY STREETS, REGARDLESS OF THE JURISDICTION OF THE UTILITY, THE MINIMUM COVER FROM THE TOP OF THE INSTALLED PAVEMENT TO THE TOP OF THE INSTALLED PIPE SHALL BE THE PAVEMENT SECTION THICKNESS (ALL BITUMINOUS AND AGGREGATE MATERIAL ABOVE THE SUBGRADE) PLUS 1-0". IF THE STANDARD PRACTICE OF THE UTILITY THAT HAS JURISDICTION OVER THE INSTALLATION HAS A MORE STRINGENT COVER REQUIREMENT, THE MORE STRINGENT REQUIREMENT SHALL GOVERN.	BARMING AND THE IDEAS, DESIGNS AND CONCEPTS CONTAINED HEREIN ARE THE EXCLUSIVE INTELLECTUAL PROPERTY OF THE SCHNEIDER CORPORATION, AND ARE NOT TO BE USED OR REPRODUCED, IN WHOLE OR IN PART, WITHOUT THE WRITTEN CONSENT OF THE SCHNEIDER CORPORATION.
	SCALE: 1"=50'	Kit<
OF 36" RCP @ 0.21%	D D D D D D D D D D D D D D D D D D D	Village of WestClay SECTION 6001 CARMEL, INDIANA BRENWICK DEVELOPMENT CO. CARMEL, INDIANA
This information was gathered for input into the Hamilton County Geographic Information System (GIS). This document is considered an official record of the GIS. Entry Date: 12-31-07 Entered By: 5LM	HORZ.: 1"=50' VERT.: 1"=5'	DATE: 3/1/05 PROJECT NO.: 1238.6001 DRAWN BY: DCC SHEET TITLE: STORM SEWER PLAN & PROFILE DRAWING FILES: N: \1238\6001\DWGS\C601-609.DWG XREF: 6001-BS.DWG XREF: 6002-BS.DWG XREF: 6003-BS.DWG XREF: 6003-BS.DWG XREF: CA21.DWG XREF: STORM.DWG SHEET NO.:

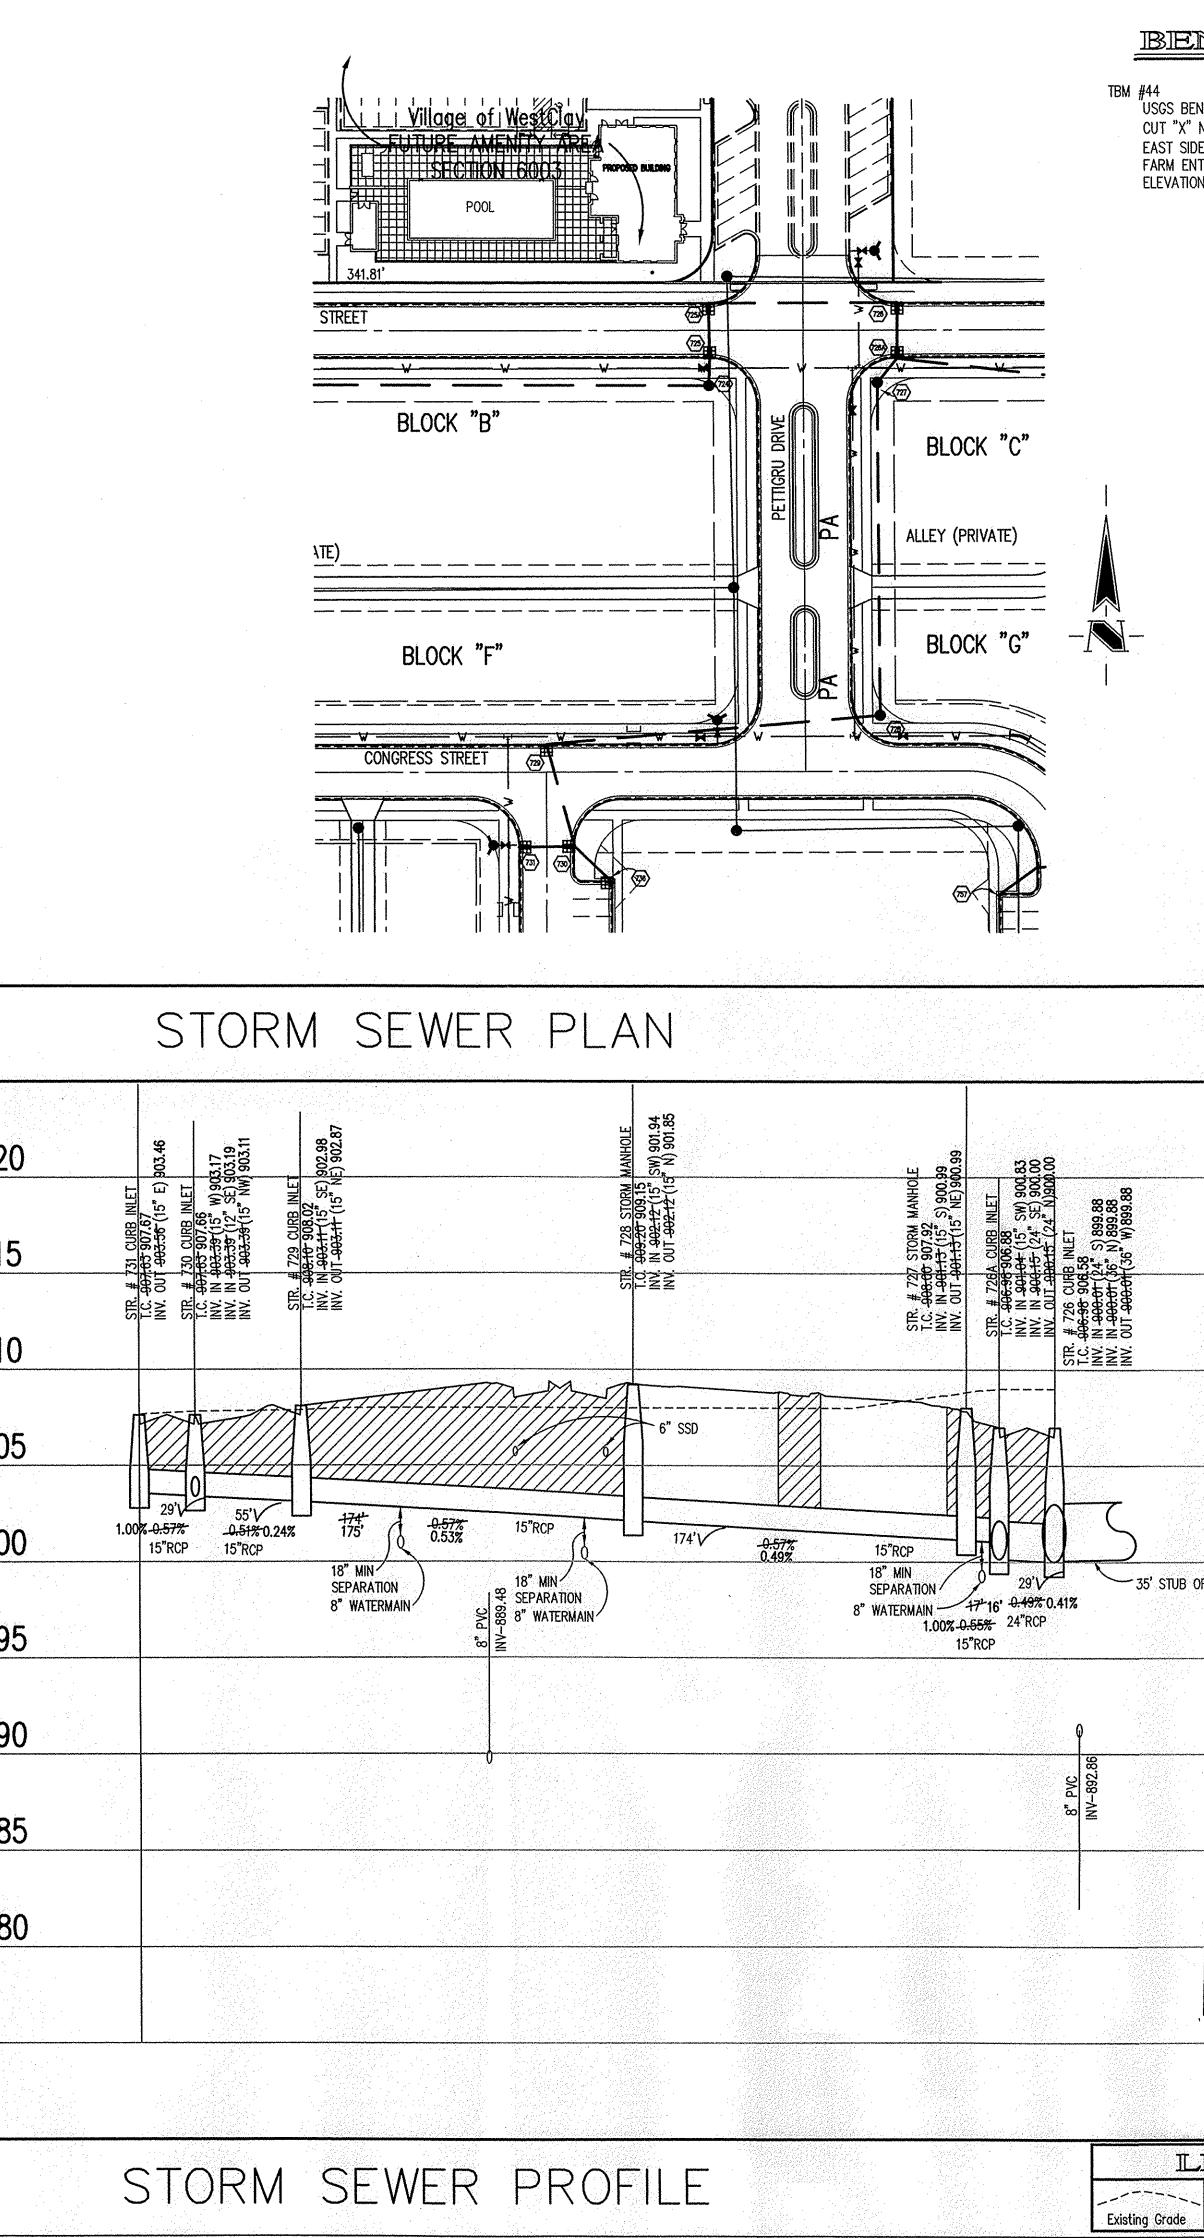


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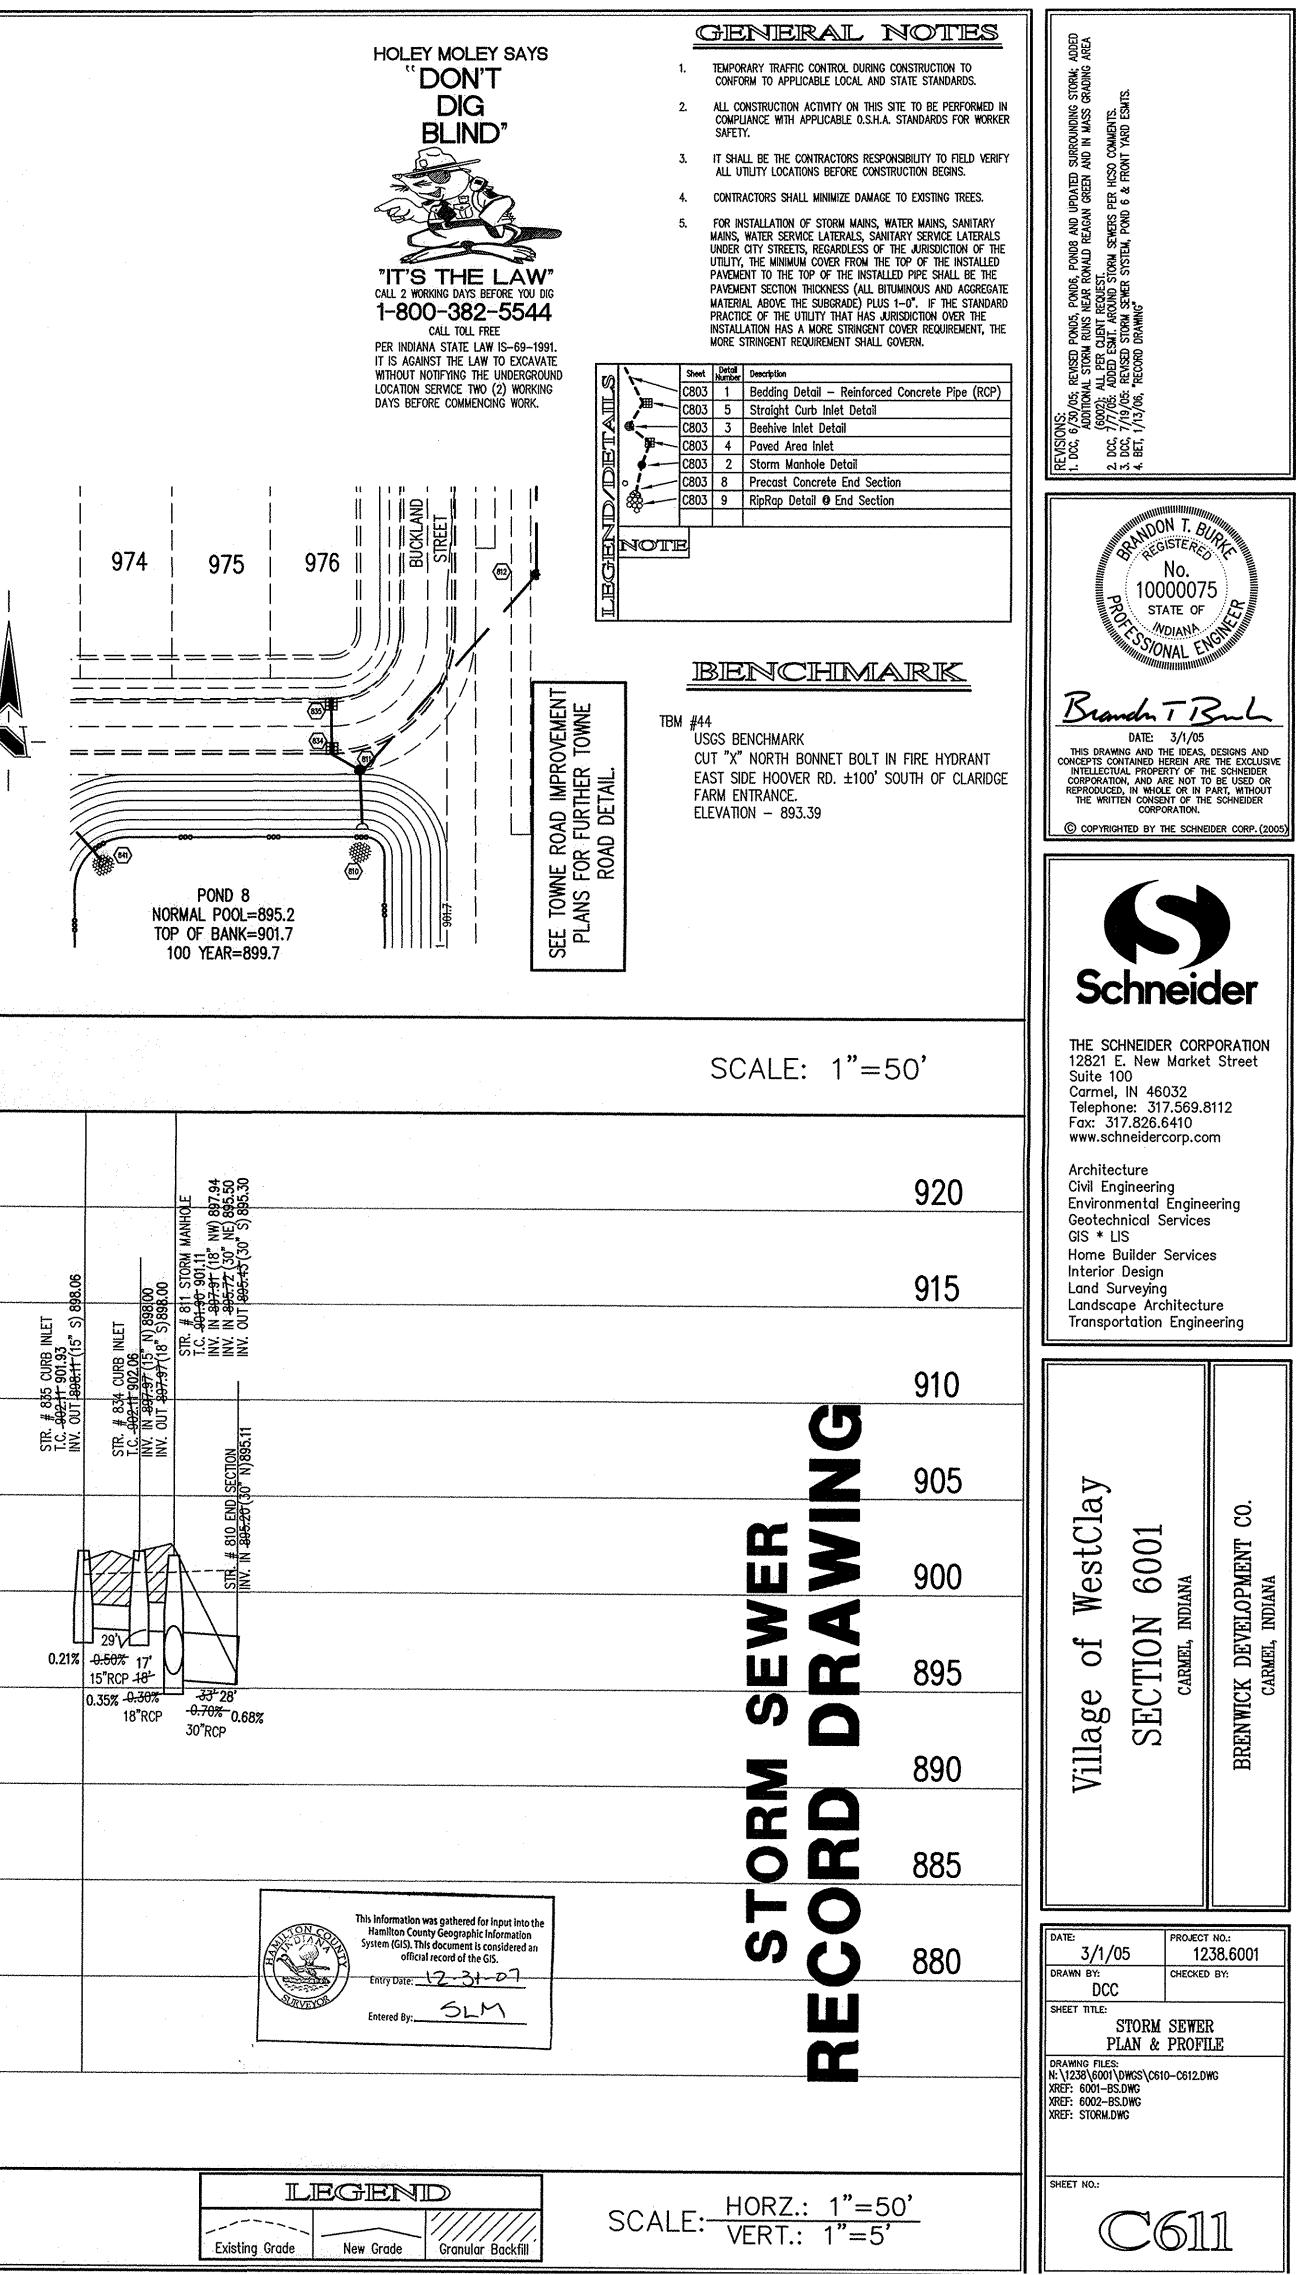
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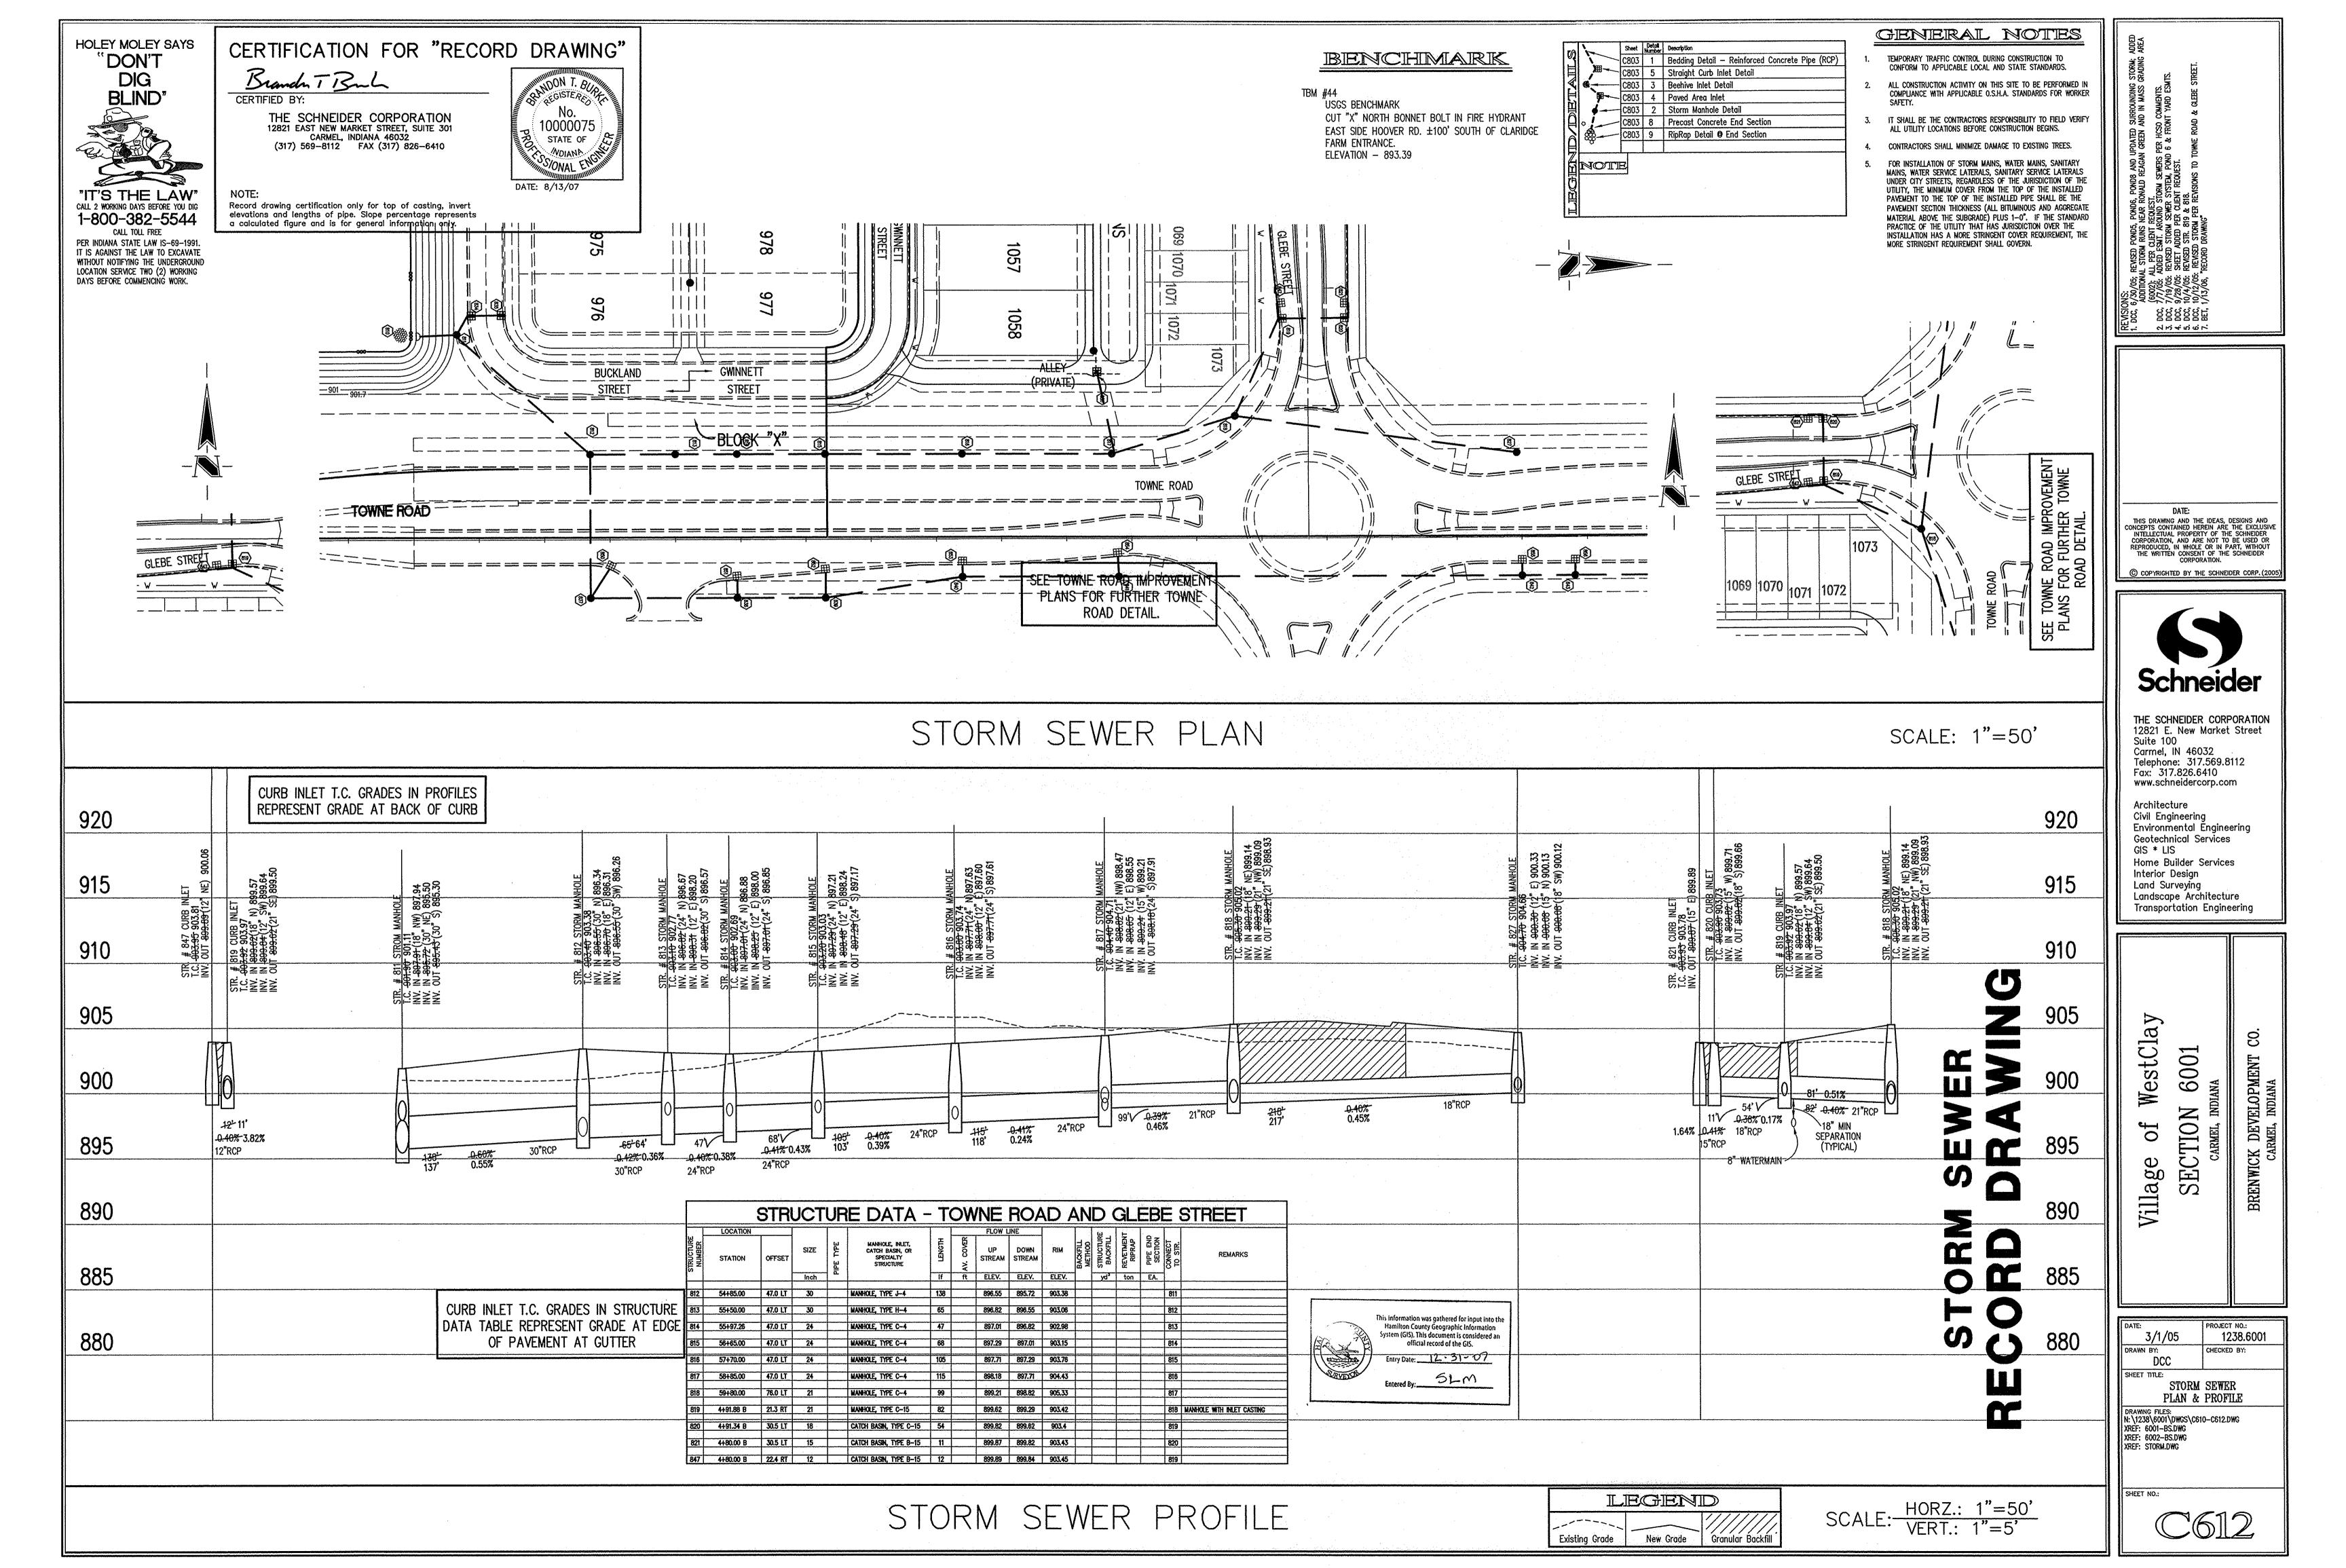
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STORM SEWER PROFILE

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Kenton C. Ward, CFM Surveyor of Hamilton County Phone (317) 776-8495 Fax (317) 776-9628 Suite 188 One Hamilton County Square Noblesville, Indiana 46060-2230

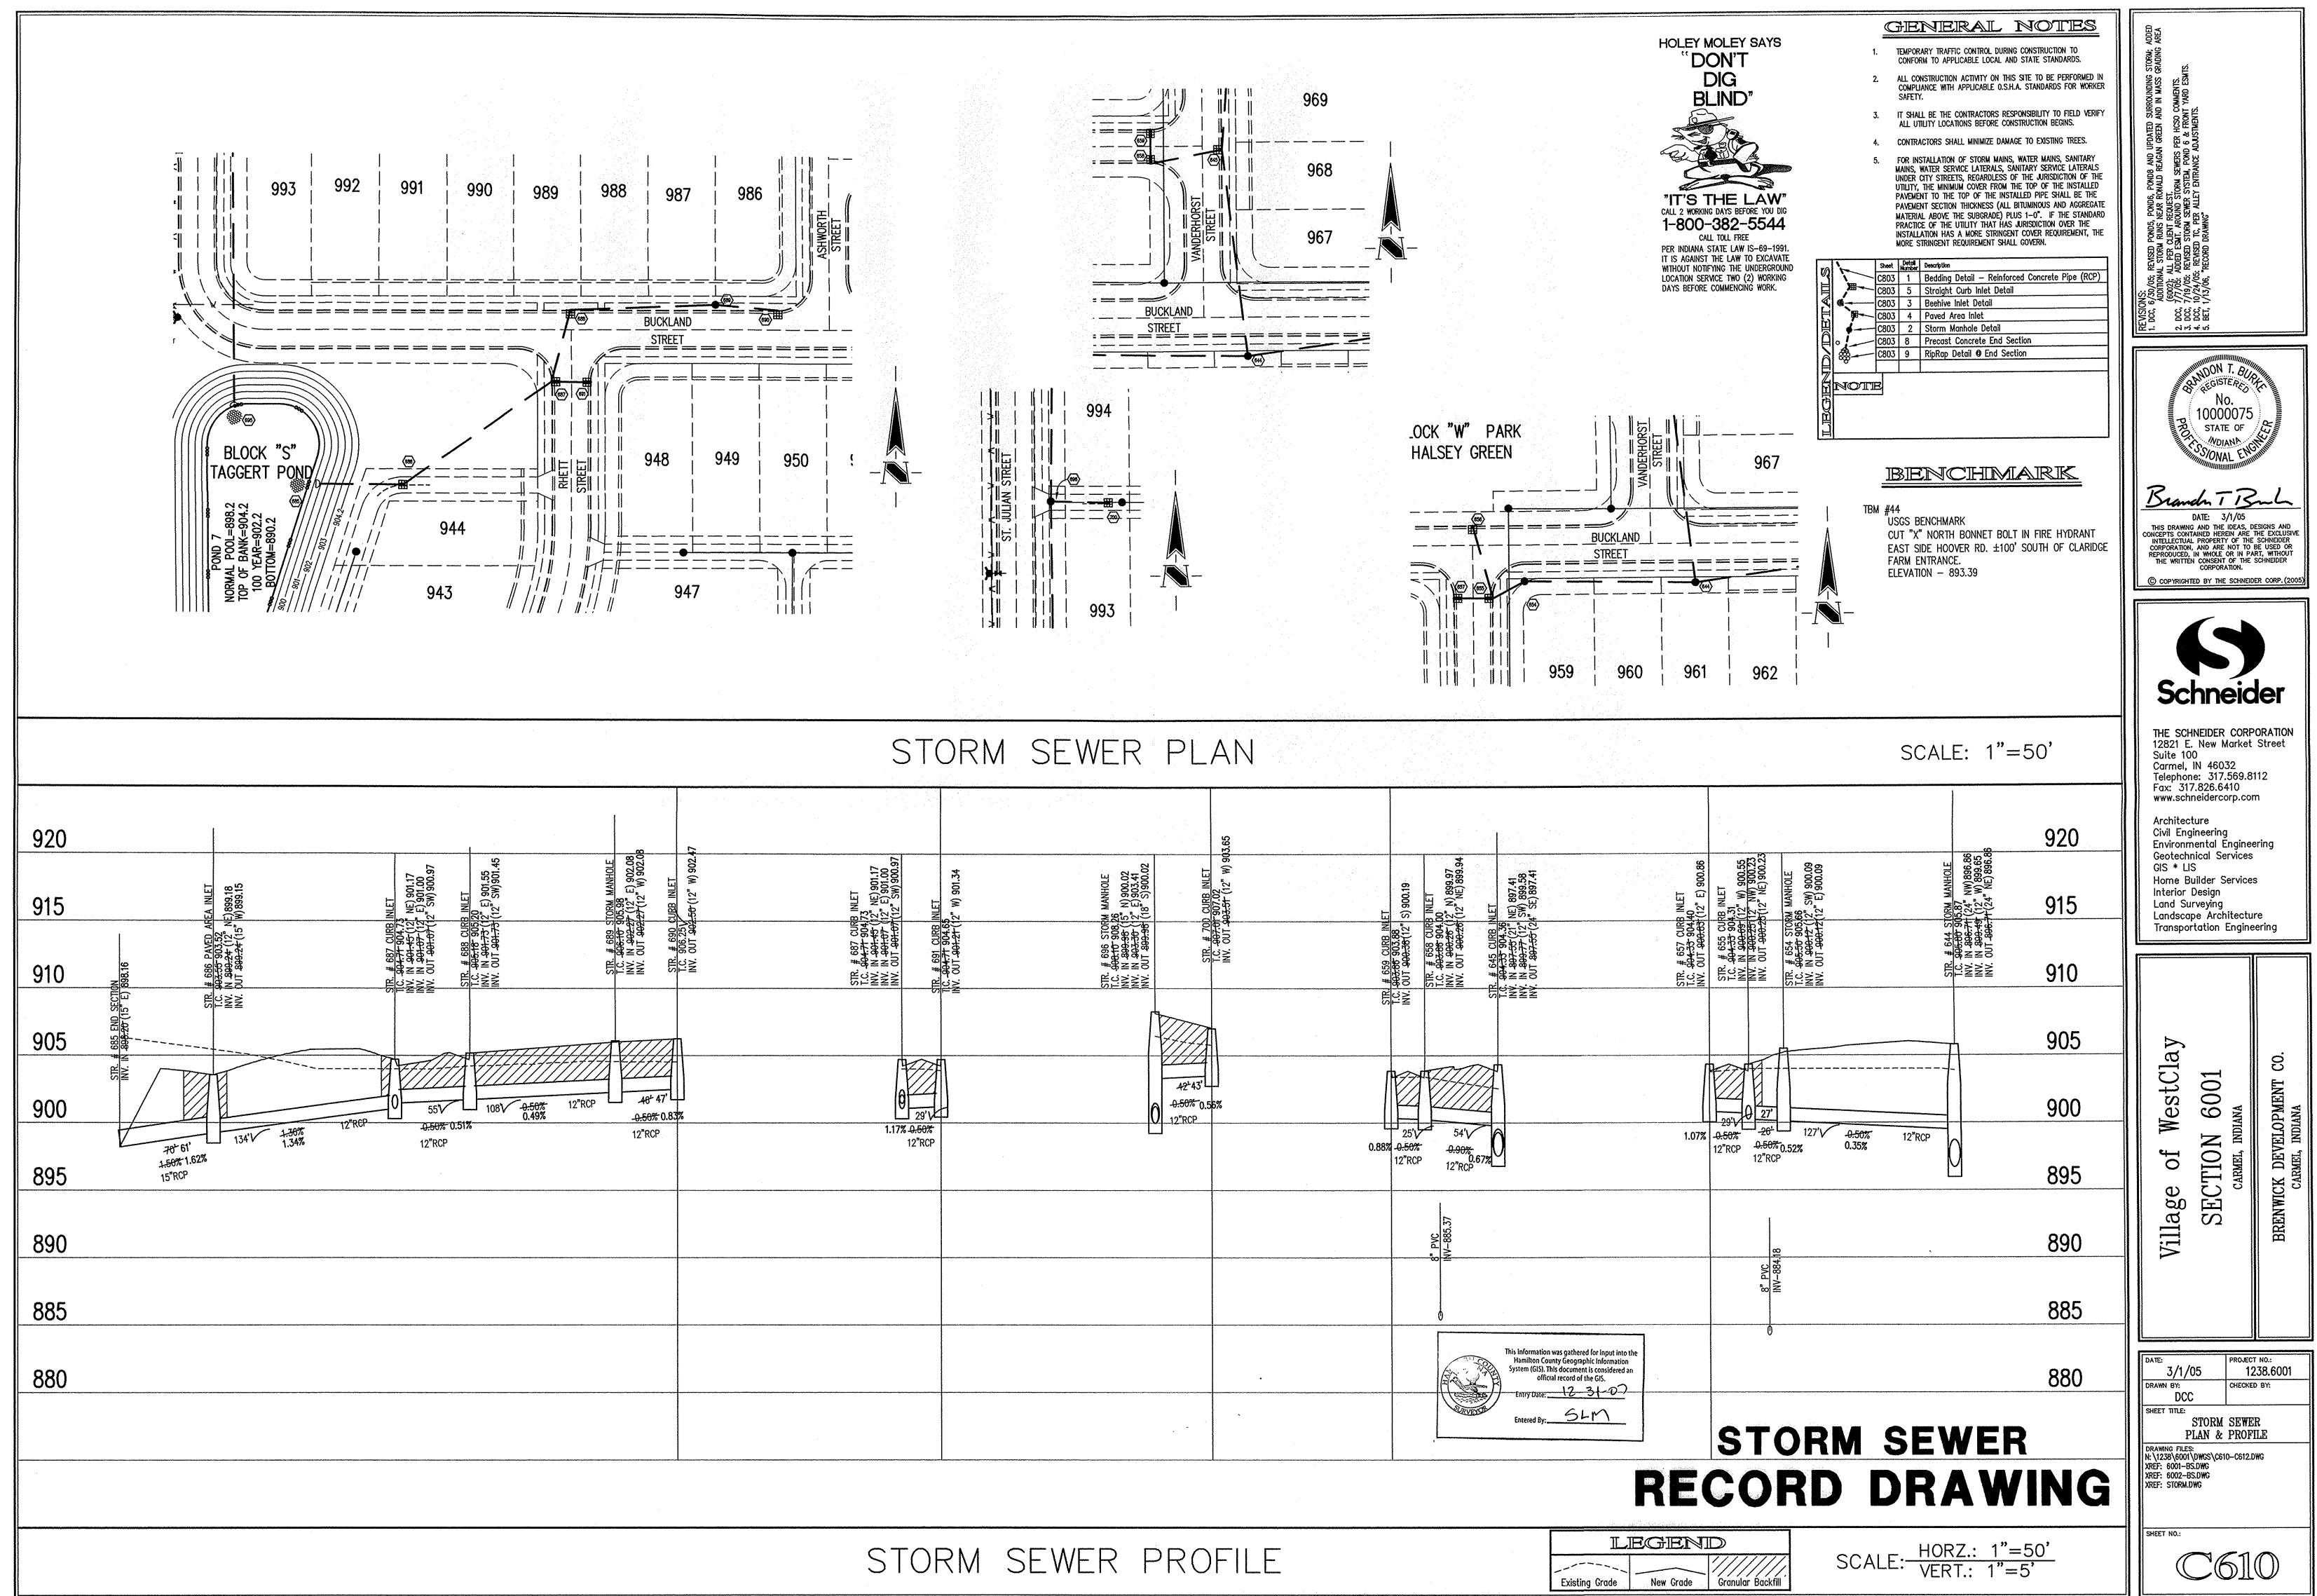Map Correction-Field Verification

Drain Number: #312

Drain Length: 8086

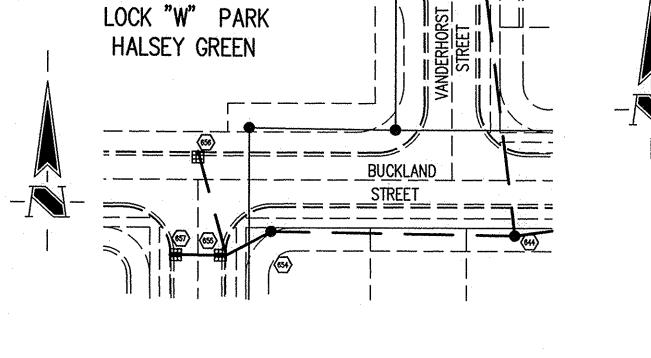Drain Name: Village of West Clay 6001 & 6002 Change + / -: 29

Date: 11-16-2016

New Length: 8115

Verified By: SLM

Notes & Sketch: Missed this section of 12" RCP on Final Report. (Str.682-648)

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Suzanne L. Mills GIS Specialist